

FOUNDATION TO FIRST FLOOR COLUMN LAYOUT PLAN

NOTE

- 1- FOR GENERAL NOTES REFER DWG NO.635/S/100
- 2- ALL DIMENSIONS ARE IN mm.
- 3- CON. MIX -M25.
- 4- GRADE OF REIN - Fe 500.
- 5- THIS DWG. SHALL BE READ WITH ALL RELEVANT ARCH. DRAWING.

Rev	Date	Description

 **Ashiana Housing Ltd.**
Unit no.4 & 5,Plot No.D-2,3rd Floor,
Southern park, saket District Centre,
Saket New Delhi - 110017
Phone no. 011- 42 65 42 65

PROJECT :
ASHIANA UMANG
AT JAIPUR
ARCHITECT

b.sengupta architect
A305,RANGOLI,ASHIANAVILLAGEBHIWADI.
PH . 09887488263



RK Bhola (C.E.A.I-M-313)

STRUCTURE ENGINEERS
 **CIVTECH CONSULTANTS PVT LTD**
B-62, LAJPAT NAGAR-IV, NEW DELHI-110 024
A-45 , SECTOR -4 , NOIDA-201301
PH. NO: 0120-2544084, E-mail - Projects@civtech.in

BUILDING TYPE ASHIANA UMANG COMMERCIAL

DRG. TITLE: SALES OFFICE
COLUMN LAYOUT PLAN


SCALE: NTS **KEY IN:**

DATE.: 13-05-2024 **PLOTTED ON:**

DRAWN BY MAHENDER **CHECKED** DEEPAK **APPROVED BY:** RKB.

DRG. NO.:- 682/S/COM/102 **SHEET** 1/2

ISSUED FOR:- SUBMISSION **REV.**

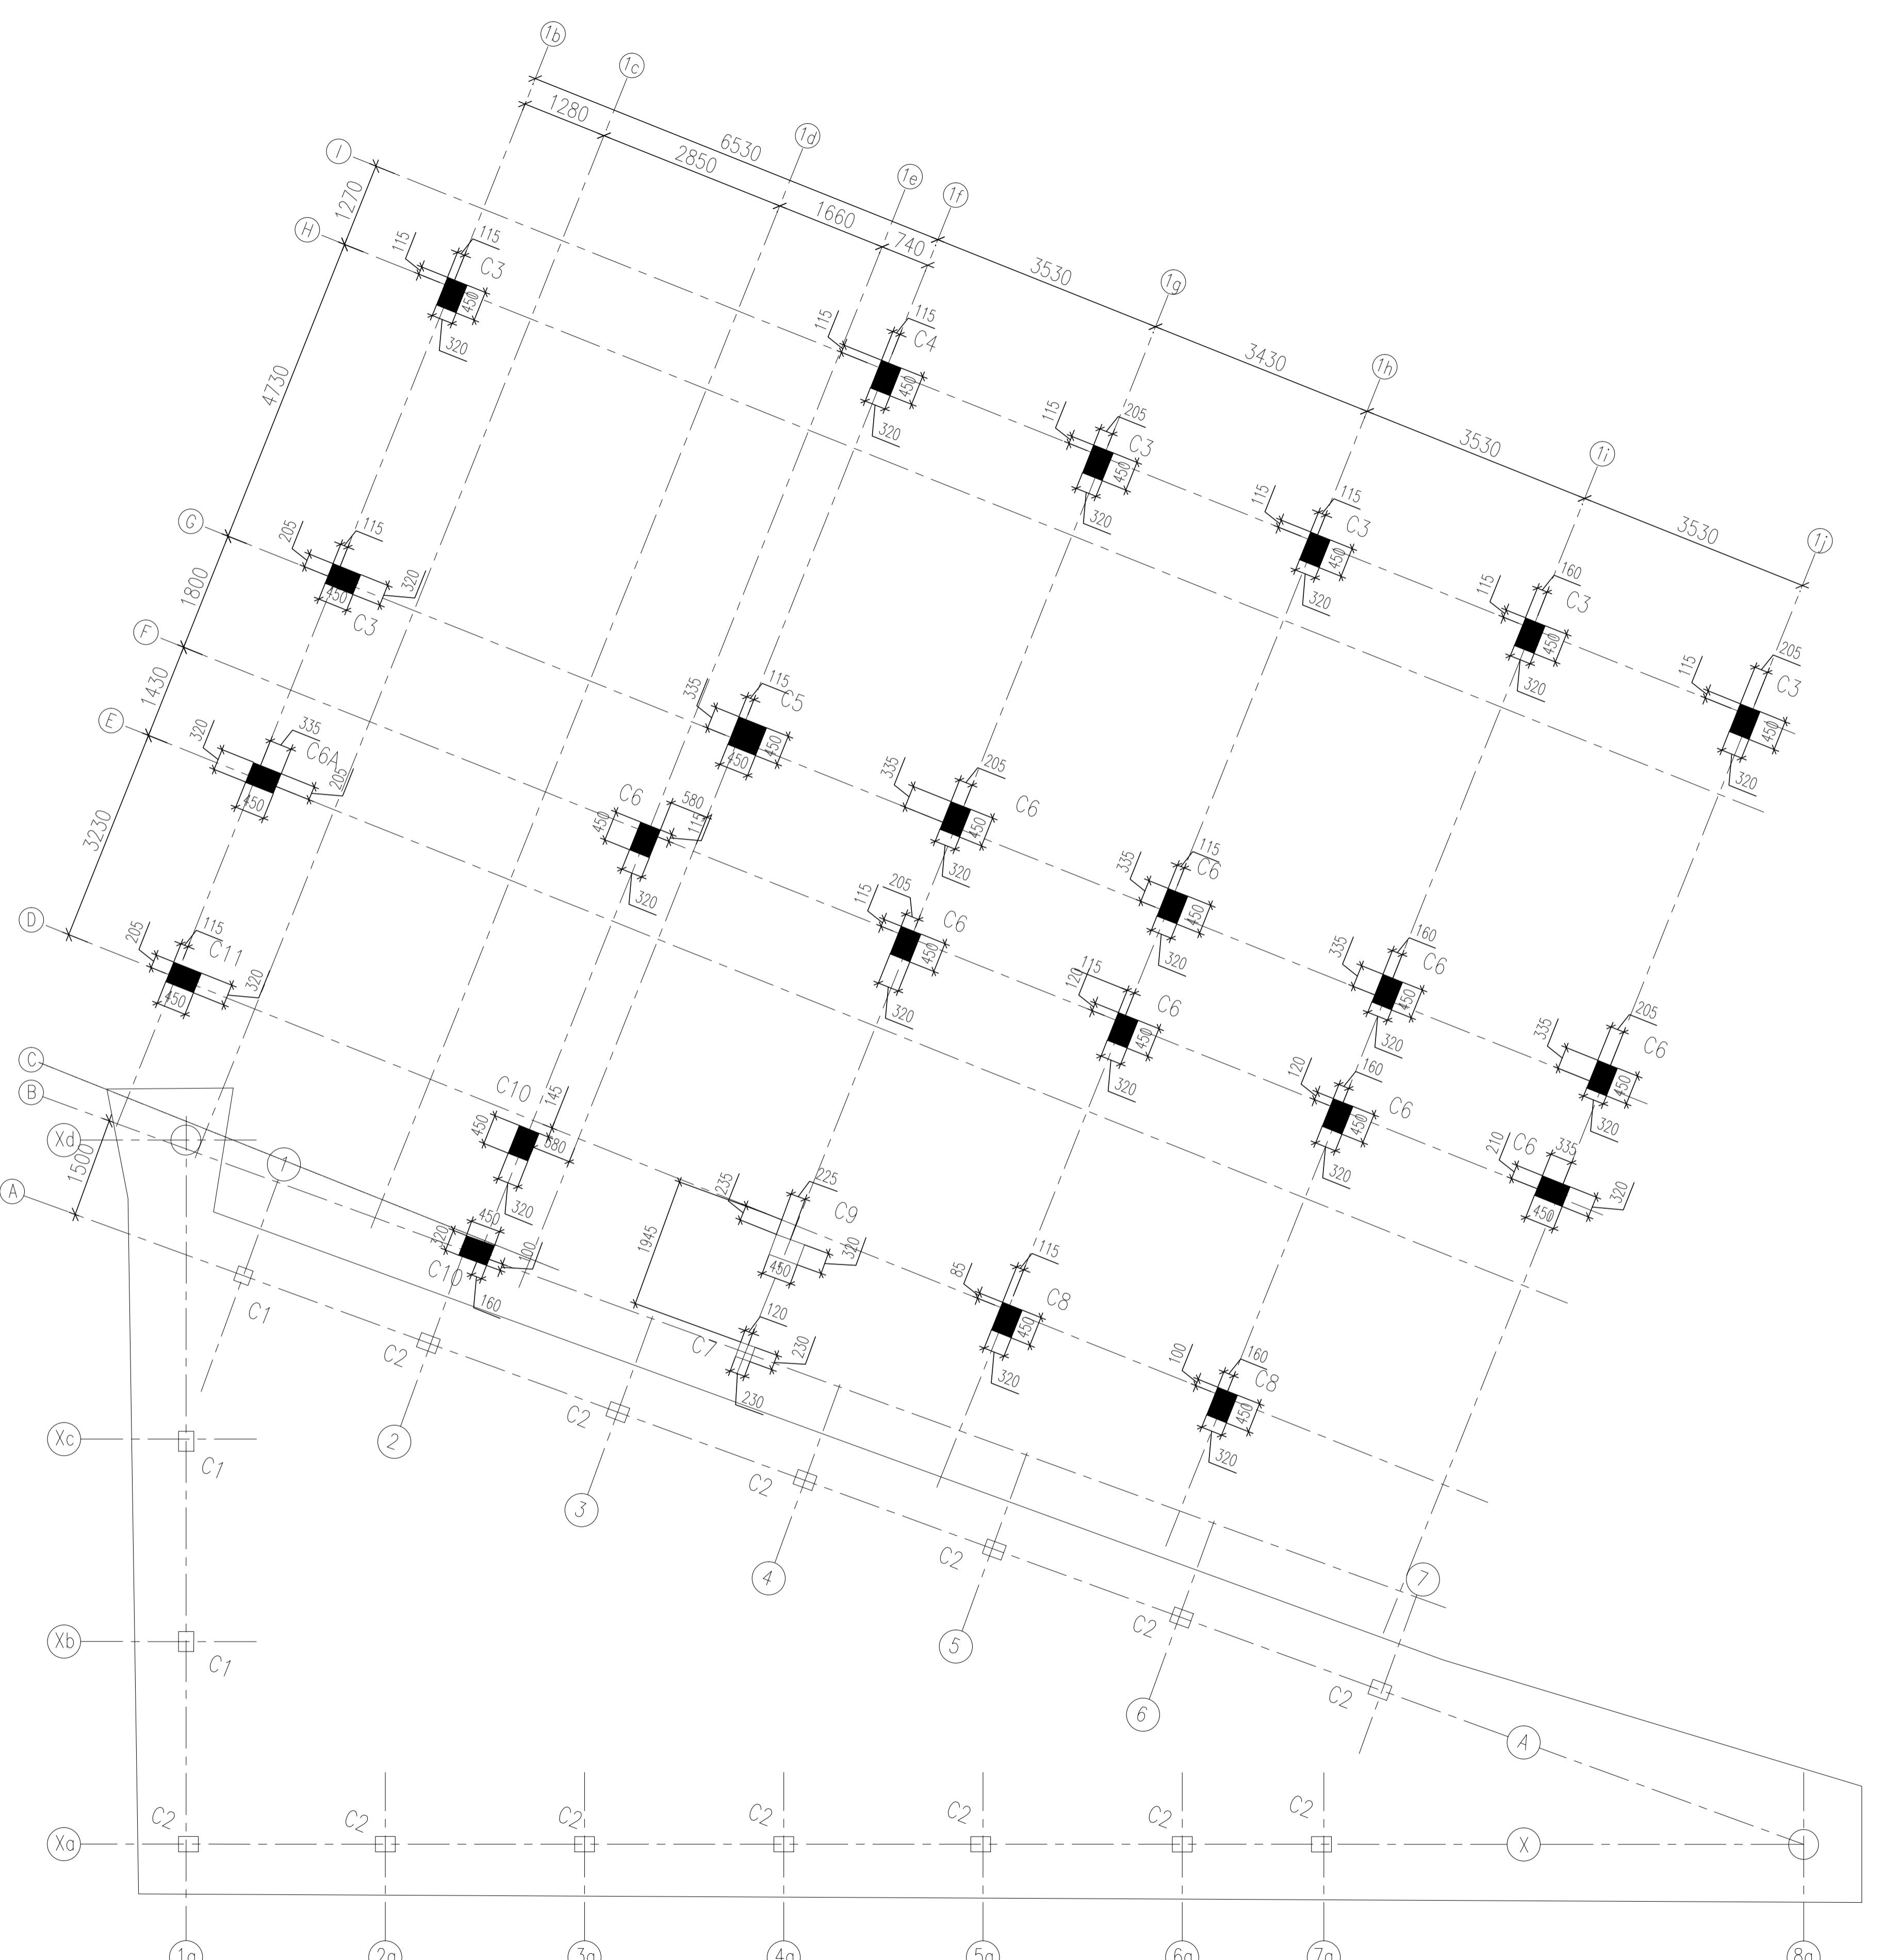

FIRST TO SECOND FLOOR COLUMN LAYOUT PLAN

RK Bhola (C.E.A.I-M-313)



NOTE

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ARCH. DRAWING.

 Ashiana Housing Ltd.

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AT JAI OR
ARCHITECT
b.sengupta architect
A305,RANGOLI,ASHIANAVILLAGEBHIWADI.
PH 09887488263

STRUCTURE ENGINEERS

CIVTECH CONSULTANTS PVT LTD

B-62, LAJPAT NAGAR-IV, NEW DELHI-110 024

A-45 , SECTOR -4 , NOIDA-201301

BUILDING

DRG. TITLE:	SALES OFFICE COLUMN LAYOUT PLAN
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SCALE: $\frac{1}{100}$ KEY IN:

DATE : 13.05.2024 PLOTTED ON:


DATE..	15-05-2024	
DRAWN BY:	CHECKED	APPROVED BY:

DRAWN BY	CHECKED	APPROVED BY.
MAHENDER	DEEPAK	RKB.

MANUFACTURER

DRG. NO. :- 682/S/COM/102A SHEET 2/2


ISSUED FOR:- SUBMISSION REV.

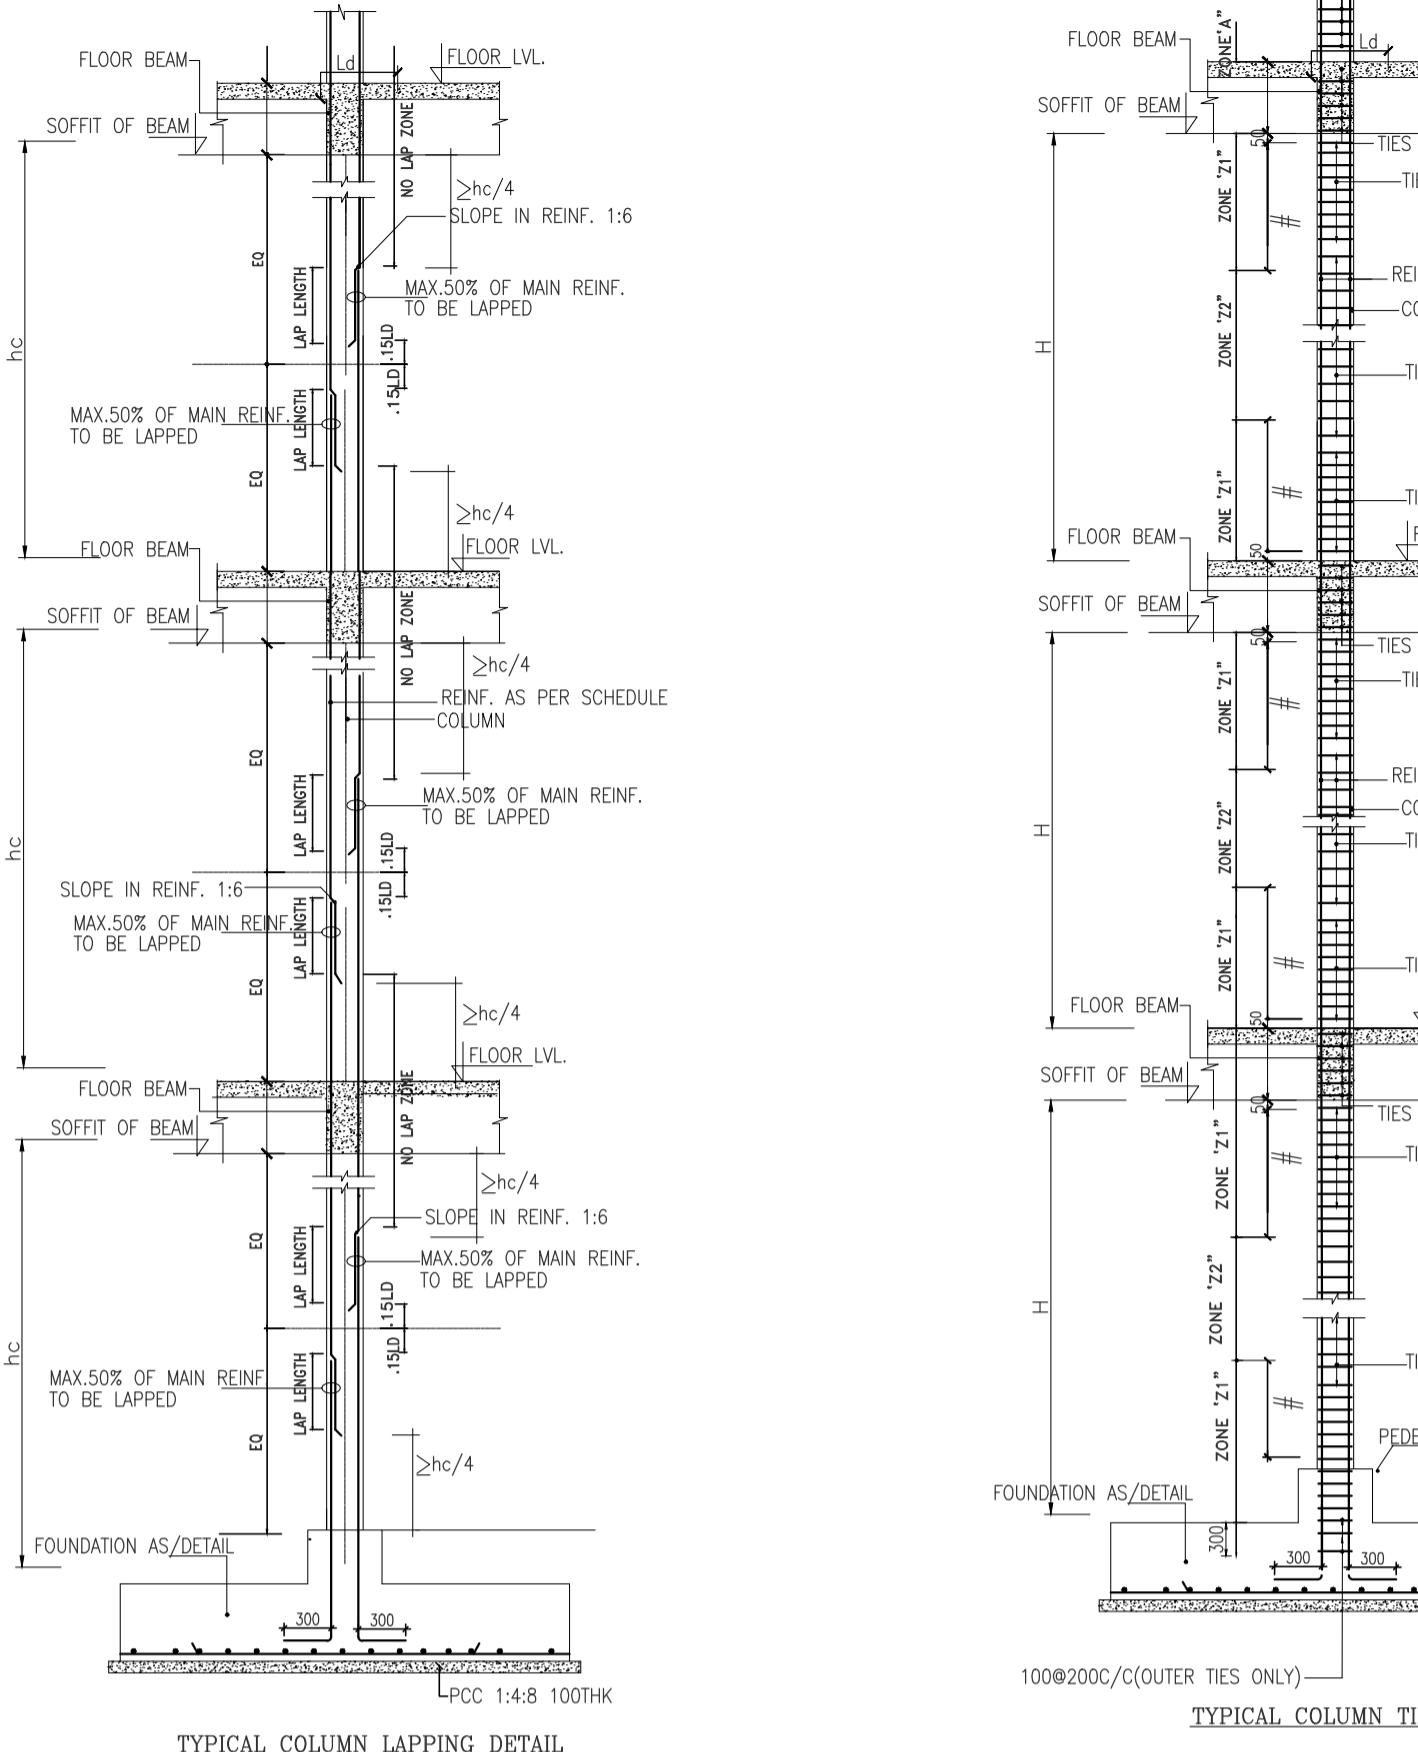

TYPICAL COLUMN LAPPING DETAIL
COLUMN VERTICAL BARS TO BE LAPPED ALTERNATIVELY
IN ONE POSITION WITH STAGGERING NOT MORE THAN
50% BARS TO BE LAPPED AT ONE SECTION

1. # - $\frac{H}{6}$ OR LARGER DIMENSION OF COLUMN SIZE OR 450mm,WHICHEVER IS MORE.
2. SPACING OF TIES IN LAP LENGTH WILL NOT BE GREATER THAN 150mm

* PROVIDE HALF SPECIAL CONFINING REINFORCEMENT REQUIRED IN ZONE

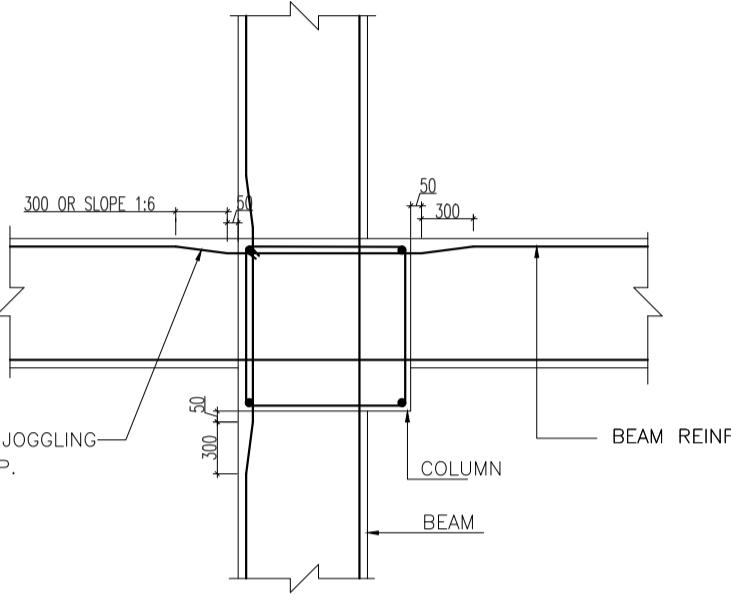

REINFORCEMENT DETAILS AT
COL.& BEAM JUNCTION (IN PLAN)

RK Bholu (C.E.A.I-M-313)



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 - 4- GRADE OF REIN - Fe 500.
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OWNERS NAME

Ashiana Housing Ltd.


o.4 & 5,Plot No.D-2,3rd Floor,
ern park, saket District Centre,
New Delhi - 110017

Phone no. 011- 42 65 42 65

SHIANA UMANG

		M30 : Fe500 , COVER = 50mm CONFINING ZONE = 545 MM	M30 : Fe500 , COVER = 50mm CONFINING ZONE = 450 MM	M30 : Fe500 , COVER = 50mm CONFINING ZONE = 450 MM	M30 : Fe500 , COVER = 50mm CONFINING ZONE = 450 MM					M30 : Fe500 , COVER = 50mm CONFINING ZONE = 675 MM			M30 : Fe500 , COVER = 50mm CONFINING ZONE = 650 MM				
2ND FLOOR	TO	Z1 MAIN LINK Z1 OTHERS Z2 LINKS	T10 @ 75 T10 @ 75 T8 @ 160	T10 @ 75 T10 @ 75 T8 @ 160	T10 @ 75 T10 @ 75 T8 @ 160	T10 @ 75 T10 @ 75 T8 @ 160	T10 @ 90 T8 @ 90 T8 @ 160										
TERRACE		T12 @ 75 T8 @ 75 T8 @ 110	T10 @ 75 T10 @ 75 T8 @ 160	T10 @ 75 T10 @ 75 T8 @ 160	T8 @ 75 T8 @ 75 T8 @ 190	T10 @ 90 T8 @ 90 T8 @ 160									T10 @ 90 T8 @ 90 T8 @ 160		
		6-T12	320 300 450 ○T12	320 300 450 ○T16 ○T12	320 300 450 ○T16 ○T12	450 450 320 300 450 ○T16 ○T12	450 450 320 300 450 ○T16 ○T12	450 450 320 300 450 ○T16 ○T12	450 450 320 300 450 ○T16 ○T12	450 450 320 300 450 ○T16 ○T12	4-T16 + 6-T12	4-T16 + 6-T12	4-T16 + 8-T12	10-T16	4-T16 + 6-T12		
1ST FLOOR	LINKS	Z1 MAIN LINK Z1 OTHERS Z2 LINKS	Z1 MAIN LINK Z1 OTHERS Z2 LINKS	Z1 MAIN LINK Z1 OTHERS Z2 LINKS	Z1 MAIN LINK Z1 OTHERS Z2 LINKS	Z1 MAIN LINK Z1 OTHERS Z2 LINKS	Z1 MAIN LINK Z1 OTHERS Z2 LINKS	Z1 MAIN LINK Z1 OTHERS Z2 LINKS	Z1 MAIN LINK Z1 OTHERS Z2 LINKS	Z1 MAIN LINK Z1 OTHERS Z2 LINKS	T8 @ 190	T12 @ 75 T8 @ 75 T8 @ 110	T10 @ 75 T10 @ 75 T8 @ 160	T10 @ 75 T10 @ 75 T8 @ 160	T10 @ 90 T8 @ 90 T8 @ 160	T10 @ 90 T8 @ 90 T8 @ 160	
TO		T12 @ 75 T8 @ 75 T8 @ 110	T12 @ 75 T10 @ 75 T8 @ 160	T10 @ 75 T10 @ 75 T8 @ 160	T8 @ 75 T8 @ 75 T8 @ 190	T10 @ 90 T8 @ 90 T8 @ 160									T10 @ 75 T10 @ 75 T8 @ 160		
2ND FLOOR		230 230 300 ○T12	230 230 300 ○T12	230 230 300 ○T12	320 300 450 ○T16 ○T12	320 300 450 ○T16 ○T12	450 450 320 300 450 ○T16 ○T12	450 450 320 300 450 ○T16 ○T12	450 450 320 300 450 ○T16 ○T12	450 450 320 300 450 ○T16 ○T12	4-T12	6-T12	6-T12	4-T16 + 6-T12	4-T16 + 6-T12		
PLINTH LEVEL	LINKS	Z1 MAIN LINK Z1 OTHERS Z2 LINKS	Z1 MAIN LINK Z1 OTHERS Z2 LINKS	Z1 MAIN LINK Z1 OTHERS Z2 LINKS	Z1 MAIN LINK Z1 OTHERS Z2 LINKS	Z1 MAIN LINK Z1 OTHERS Z2 LINKS	Z1 MAIN LINK Z1 OTHERS Z2 LINKS	Z1 MAIN LINK Z1 OTHERS Z2 LINKS	Z1 MAIN LINK Z1 OTHERS Z2 LINKS	Z1 MAIN LINK Z1 OTHERS Z2 LINKS	T10 @ 75 T10 @ 75 T8 @ 160	T10 @ 75 T10 @ 75 T8 @ 160	T8 @ 75 T8 @ 160	T8 @ 75 T8 @ 160	T10 @ 90 T8 @ 90 T8 @ 160	T10 @ 90 T8 @ 90 T8 @ 160	
TO		T10 @ 75 T10 @ 75 T8 @ 160	T10 @ 75 T10 @ 75 T8 @ 160	T8 @ 75 T8 @ 190	T10 @ 90 T8 @ 90 T8 @ 160	T10 @ 90 T8 @ 90 T8 @ 160	T8 @ 190								T10 @ 75 T10 @ 75 T8 @ 160		
1ST FLOOR		230 230 300 ○T12	230 230 300 ○T12	230 230 300 ○T12	320 300 450 ○T16 ○T12	320 300 450 ○T16 ○T12	450 450 320 300 450 ○T16 ○T12	450 450 320 300 450 ○T16 ○T12	450 450 320 300 450 ○T16 ○T12	450 450 320 300 450 ○T16 ○T12	4-T12	4-T16 + 6-T12	4-T16 + 6-T12	10-T16	10-T16	4-T16 + 6-T12	
BASE	EXISTING COLUMN	M30 : Fe500 , COVER = 50mm CONFINING ZONE = FULL HEIGHT	M30 : Fe500 , COVER = 50mm CONFINING ZONE = FULL HEIGHT	M30 : Fe500 , COVER = 50mm CONFINING ZONE = FULL HEIGHT	M30 : Fe500 , COVER = 50mm CONFINING ZONE = FULL HEIGHT	M30 : Fe500 , COVER = 50mm CONFINING ZONE = FULL HEIGHT	M30 : Fe500 , COVER = 50mm CONFINING ZONE = FULL HEIGHT	M30 : Fe500 , COVER = 50mm CONFINING ZONE = FULL HEIGHT	M30 : Fe500 , COVER = 50mm CONFINING ZONE = FULL HEIGHT	M30 : Fe500 , COVER = 50mm CONFINING ZONE = FULL HEIGHT	T10 @ 90 T8 @ 90 ---	T10 @ 75 T10 @ 75 ---	T8 @ 75 T8 @ 75 ---	T10 @ 90 T8 @ 90 ---	T10 @ 90 T8 @ 90 ---	T10 @ 75 T10 @ 75 ---	
TO		Z1 MAIN LINK Z1 OTHERS Z2 LINKS	T10 @ 90 T8 @ 90 ---	T10 @ 75 T10 @ 75 ---	T8 @ 75 T8 @ 75 ---	T10 @ 90 T8 @ 90 ---	T10 @ 90 T8 @ 90 ---	T10 @ 75 T10 @ 75 ---									
PLINTH LEVEL		10-T16	320 300 450 ○T16	10-T16	320 300 450 ○T16 ○T12	4-T16 + 6-T12	450 450 320 300 450 ○T16 ○T12	4-T16 + 8-T12	450 450 320 300 450 ○T16 ○T12	4-T16 + 8-T12	450 450 320 300 450 ○T16 ○T12	10-T16	10-T16	4-T12	4-T12	10-T16	4-T16 + 6-T12
COL MKD.	C1	C2	C2A	C3	C4	C5	C6	C6A	C7	C7A UP TO MID LANDING	C8	C9	C10	C11			


COLUMN SCHEDULE
(SCALE 1:25)

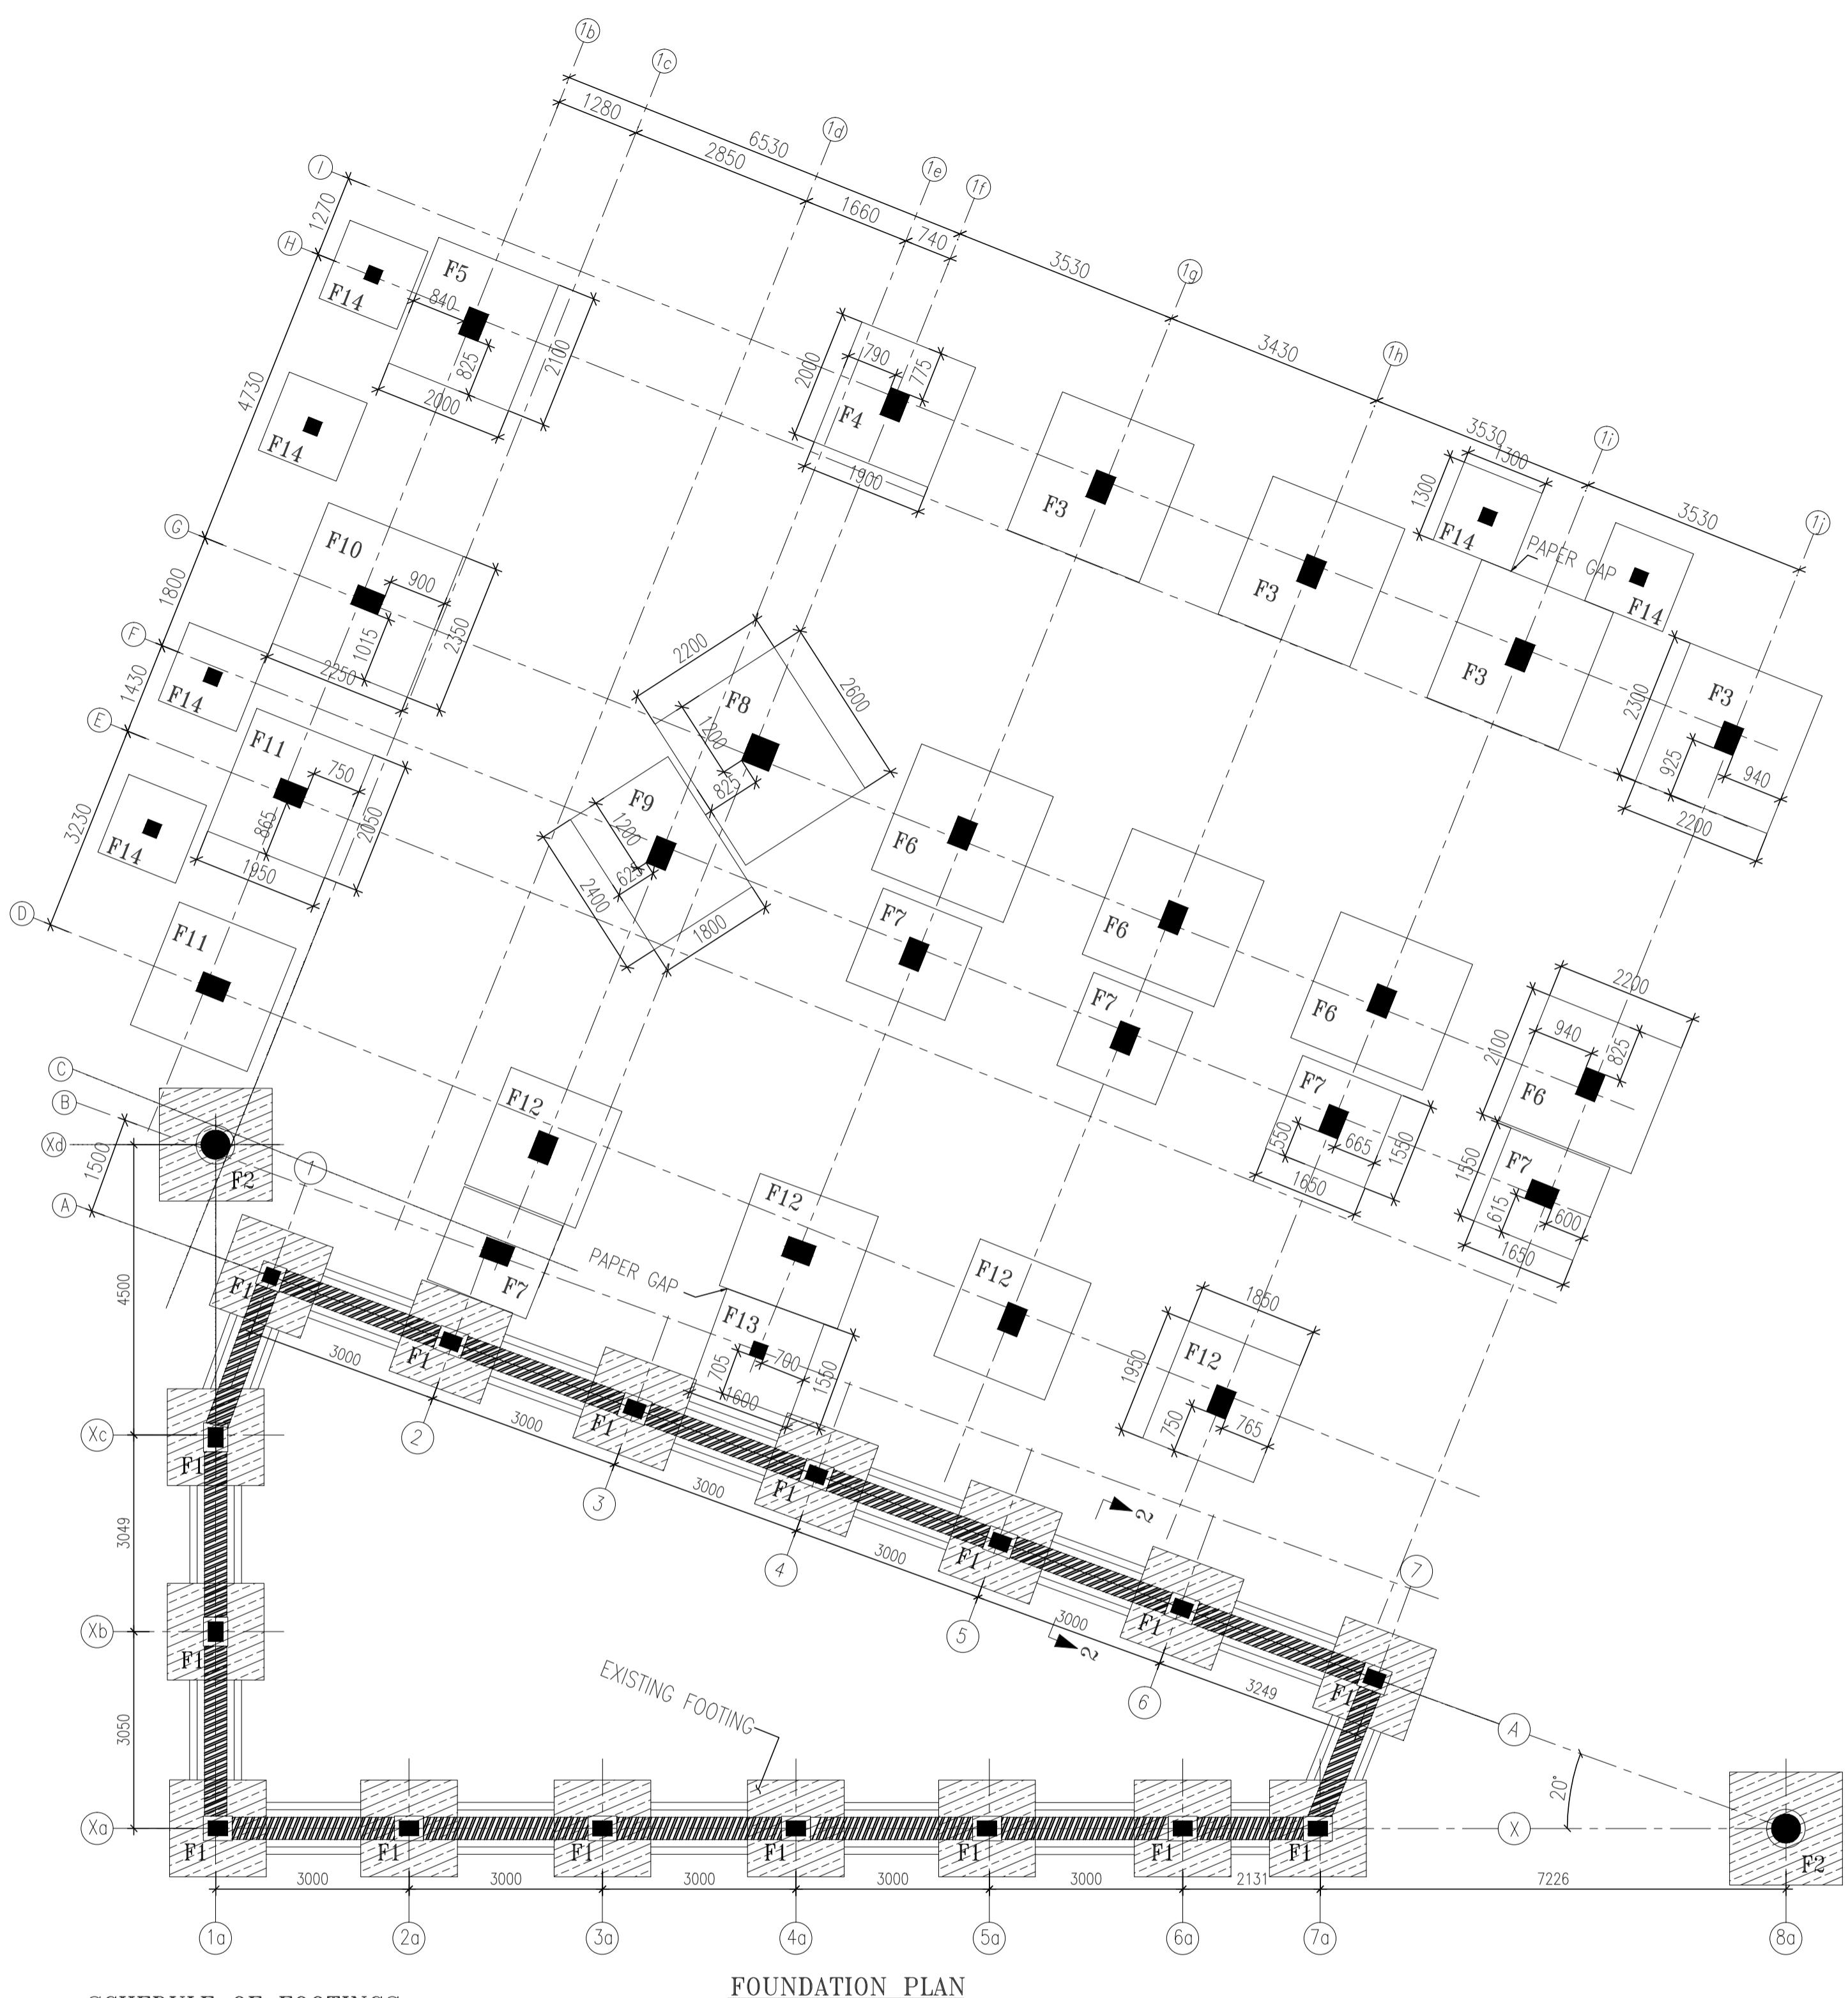


SCHEDULE OF FOOTINGS

FOUNDATION PLAN


SCHEDULE OF FOOTINGS						
FOOTING	FOOTING SIZE	DEPTH OF FOOTING	REINFORCEMENT BOTTOM		REINFORCEMENT TOP	
NO.	LxB	D	ALONG B	ALONG L	ALONG B	ALONG L
F1	1500x1500	300	10T@150c/c	10T@150c/c		
F2	1750x1750	300	10T@150c/c	10T@150c/c		
F3	2300x2200	600	12T@165c/c	12T@160c/c	10T@200c/c	10T@200c/c
F4	2000x1900	450	12T@200c/c	12T@200c/c		
F5	2100x2000	575	12T@175c/c	12T@170c/c	10T@200c/c	10T@200c/c
F6	2100x2200	500	12T@195c/c	12T@200c/c		
F7	1550x1650	375	12T@200c/c	12T@200c/c		
F8	2200x2600	600	12T@160c/c	12T@165c/c	10T@200c/c	10T@200c/c
F9	1800x2400	600	12T@165c/c	12T@160c/c		
F10	2350x2250	600	12T@170c/c	12T@165c/c	10T@200c/c	10T@200c/c
F11	2050x1950	475	12T@200c/c	12T@200c/c		
F12	1950x1850	425	12T@200c/c	12T@200c/c		
F13	1550x1600	450	12T@200c/c	12T@200c/c		
F14	1300x1300	450	12T@200c/c	12T@200c/c		

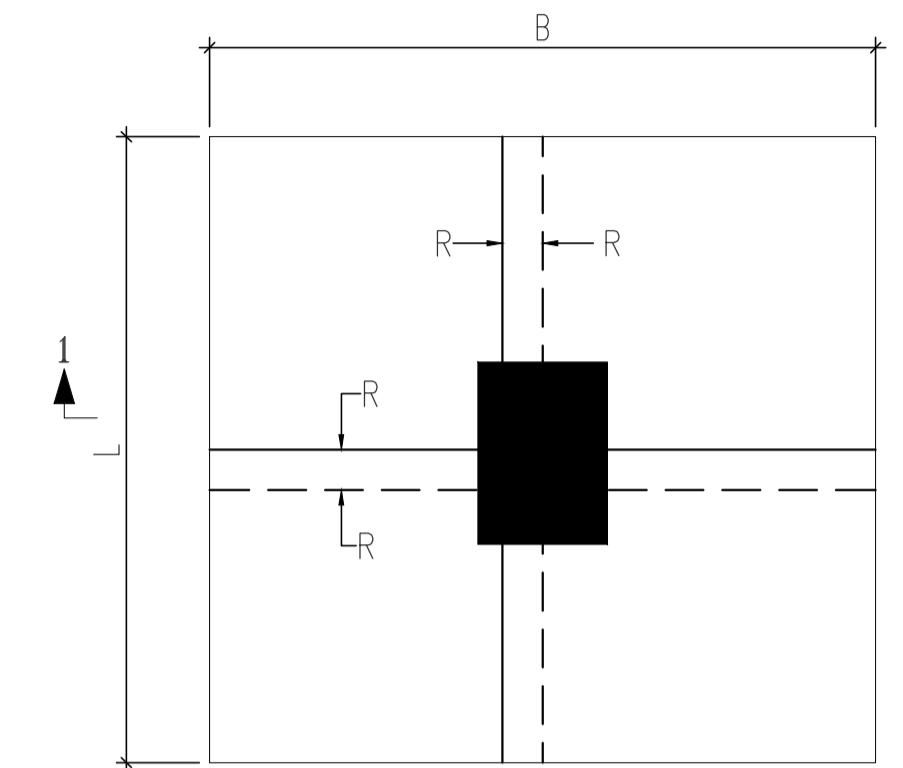

TYP. PLAN OF ISOLATED FOOTING

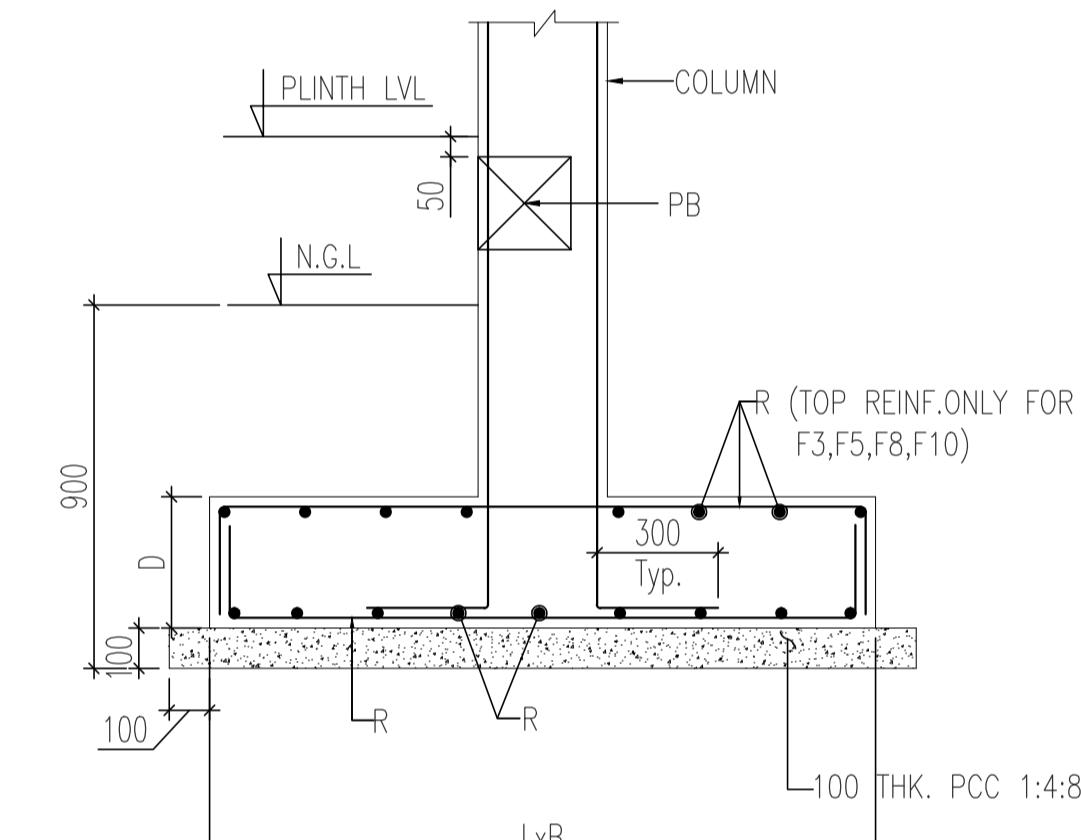

SECTION 1-

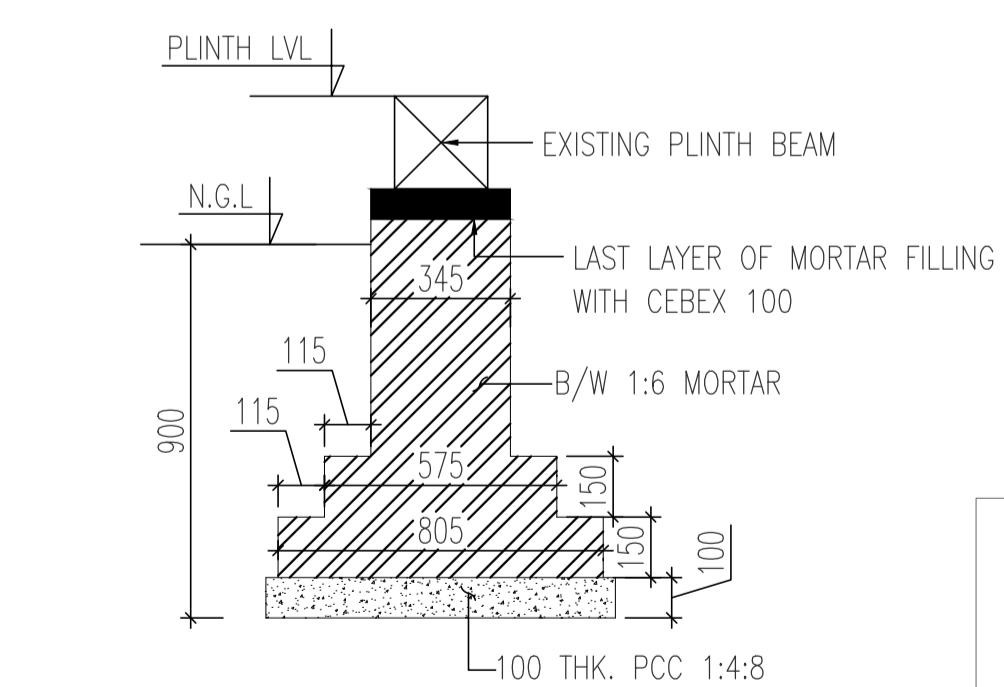

SECTION 2-2

RK Bholu (C.E.A.I-M-313)

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PROJECT :

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AT JAIPUR

AT JAIPUR

ARCHITECT

b.sengupta architect

A305,RANGOLI,ASHIANAVILLAGEBHIWADI.

PH 09887488263

STRUCTURE ENGINEERS

BUILDING ASHANA UMANA COMMERCIAL

DRG. TITLE:	SALES OFFICE FOUNDATION PLAN AND DETAIL

SCALE: **KEY IN:**

DATE : 13.05.2024 PLOTTED ON:


DRAWN BY CHECKED APPROVED BY:

MAHENDER DEEPAK RKB.

DRG. NO. :- 682/S/COM/101	SHEET	1/1
ISSUED FOR: SUBMISSION	REV:	

NOTES:-

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4. DO NOT SCALE, FOLLOW WRITTEN DIMENSIONS ONLY.
5. GRADE OF REINF. Fe 500.
6. CONC. MIX - M25 U.S.

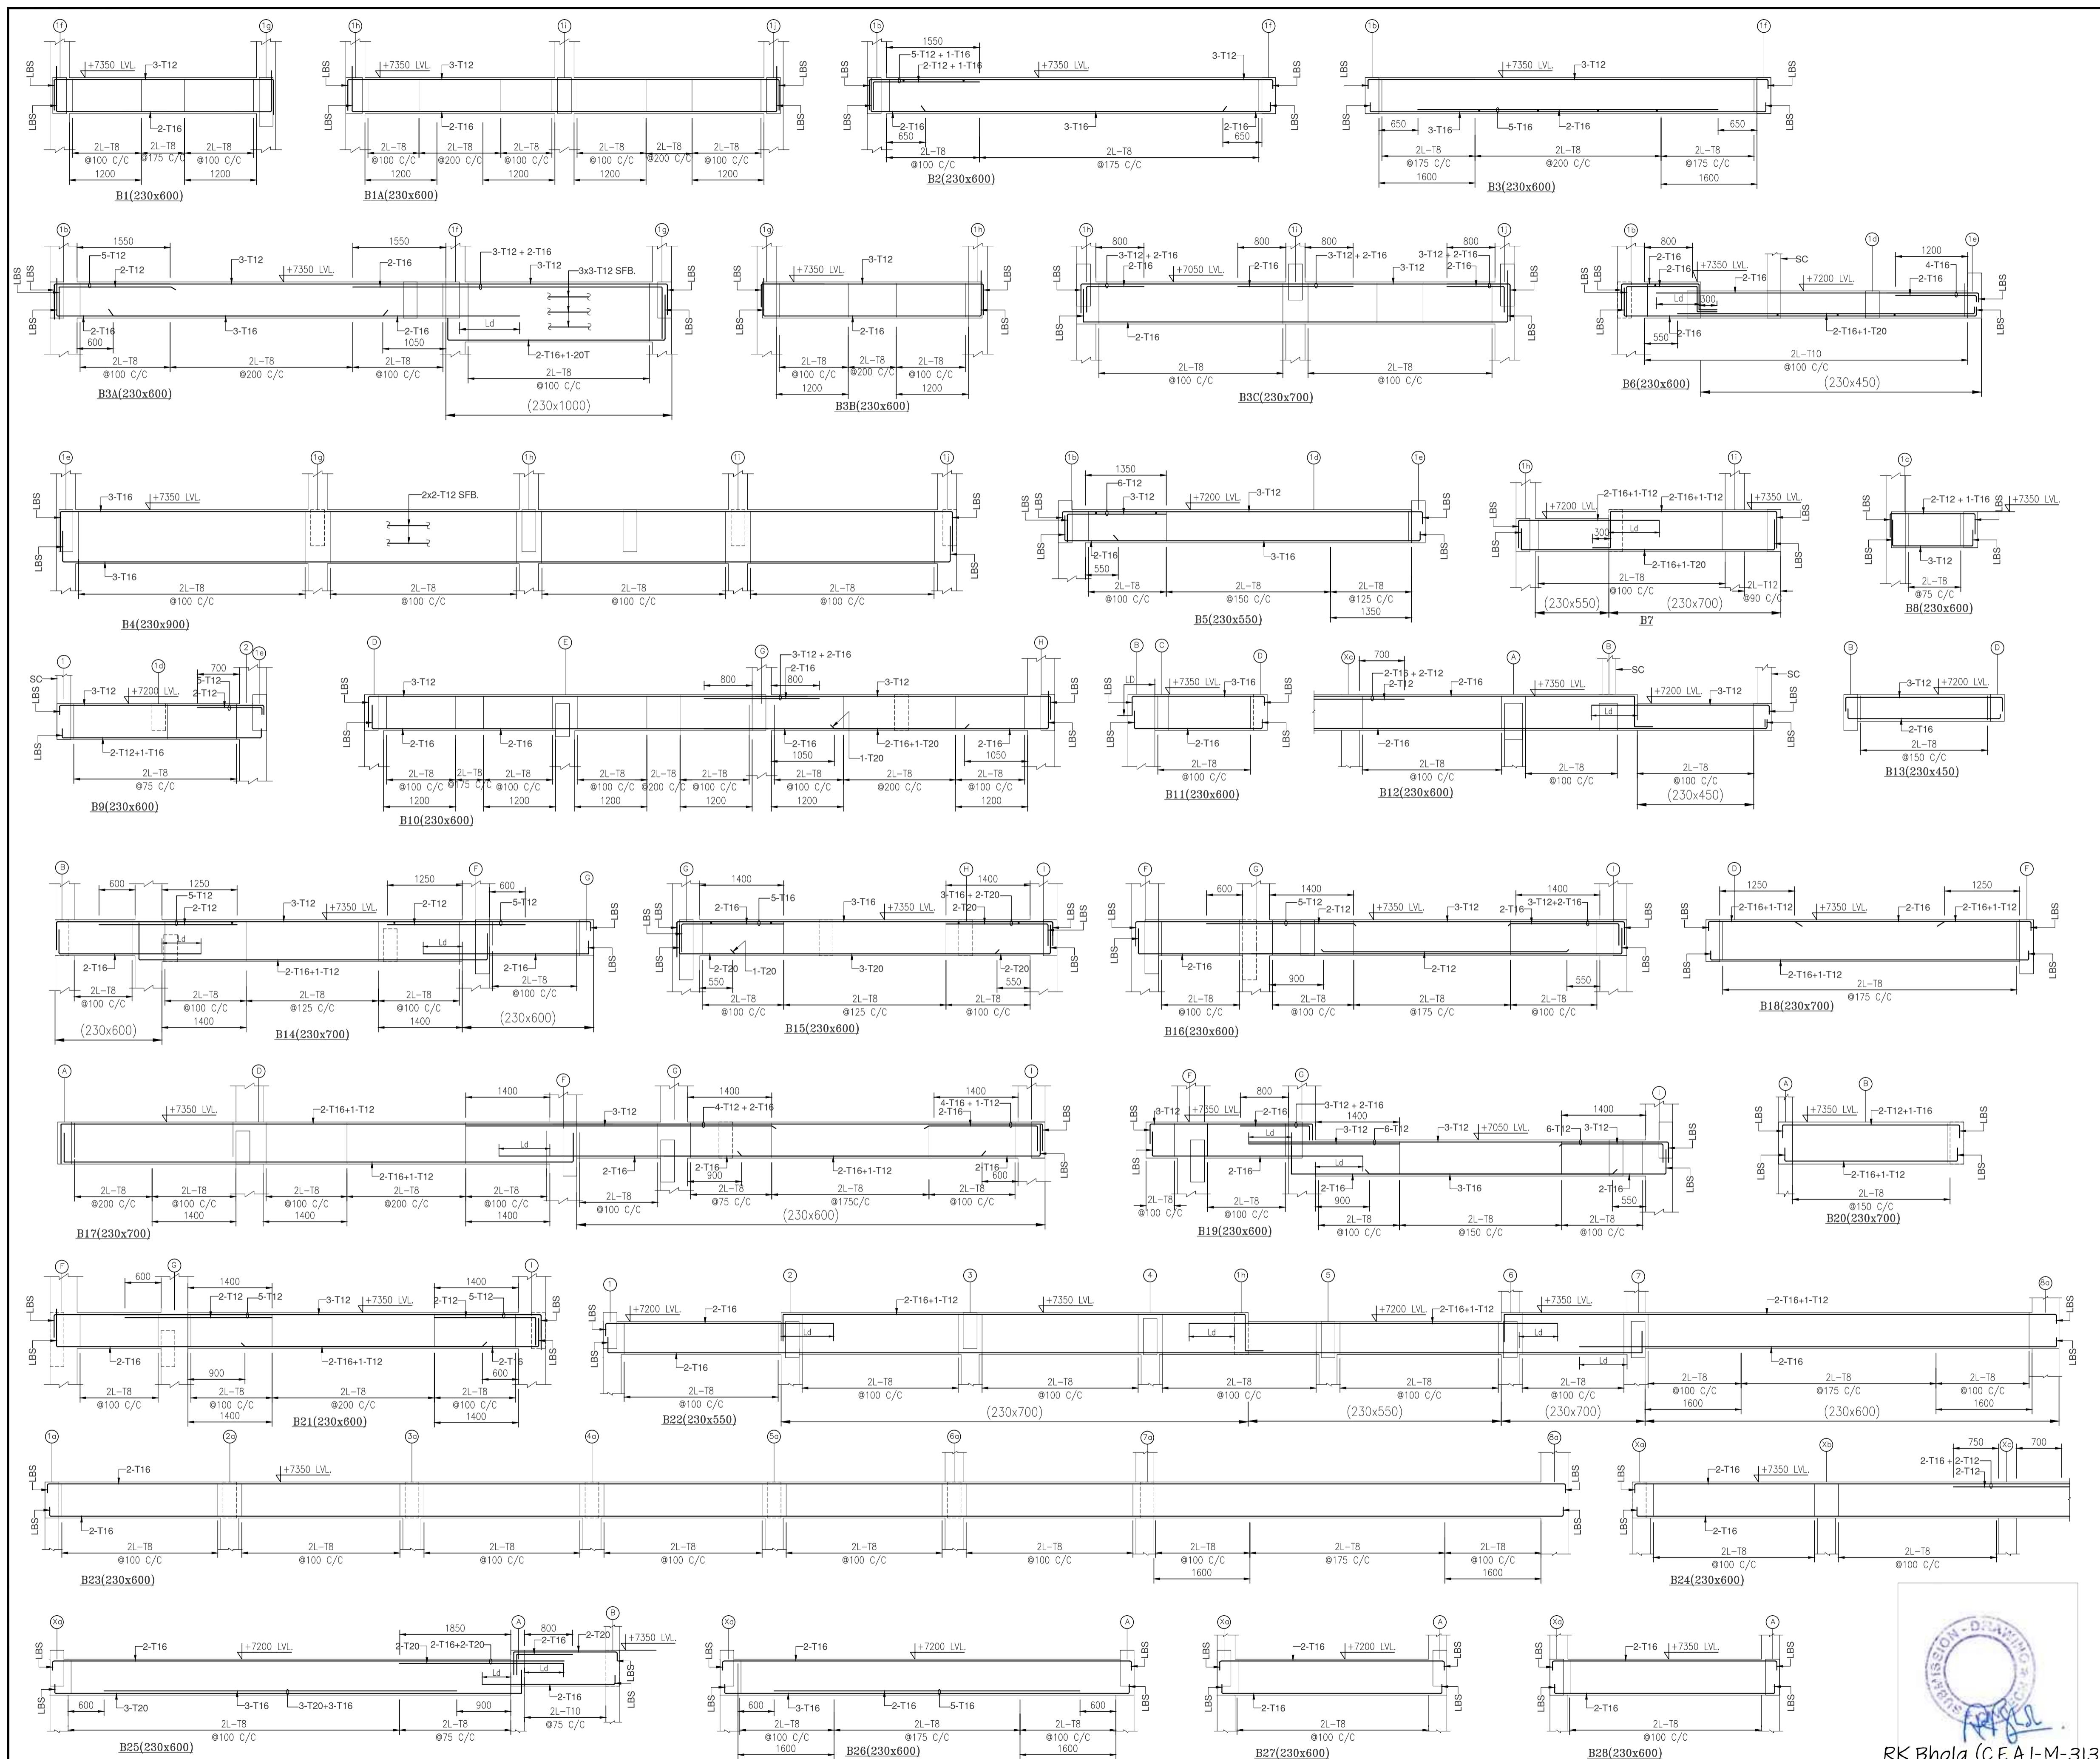

Rev	Date	Description
OWNERS NAME		

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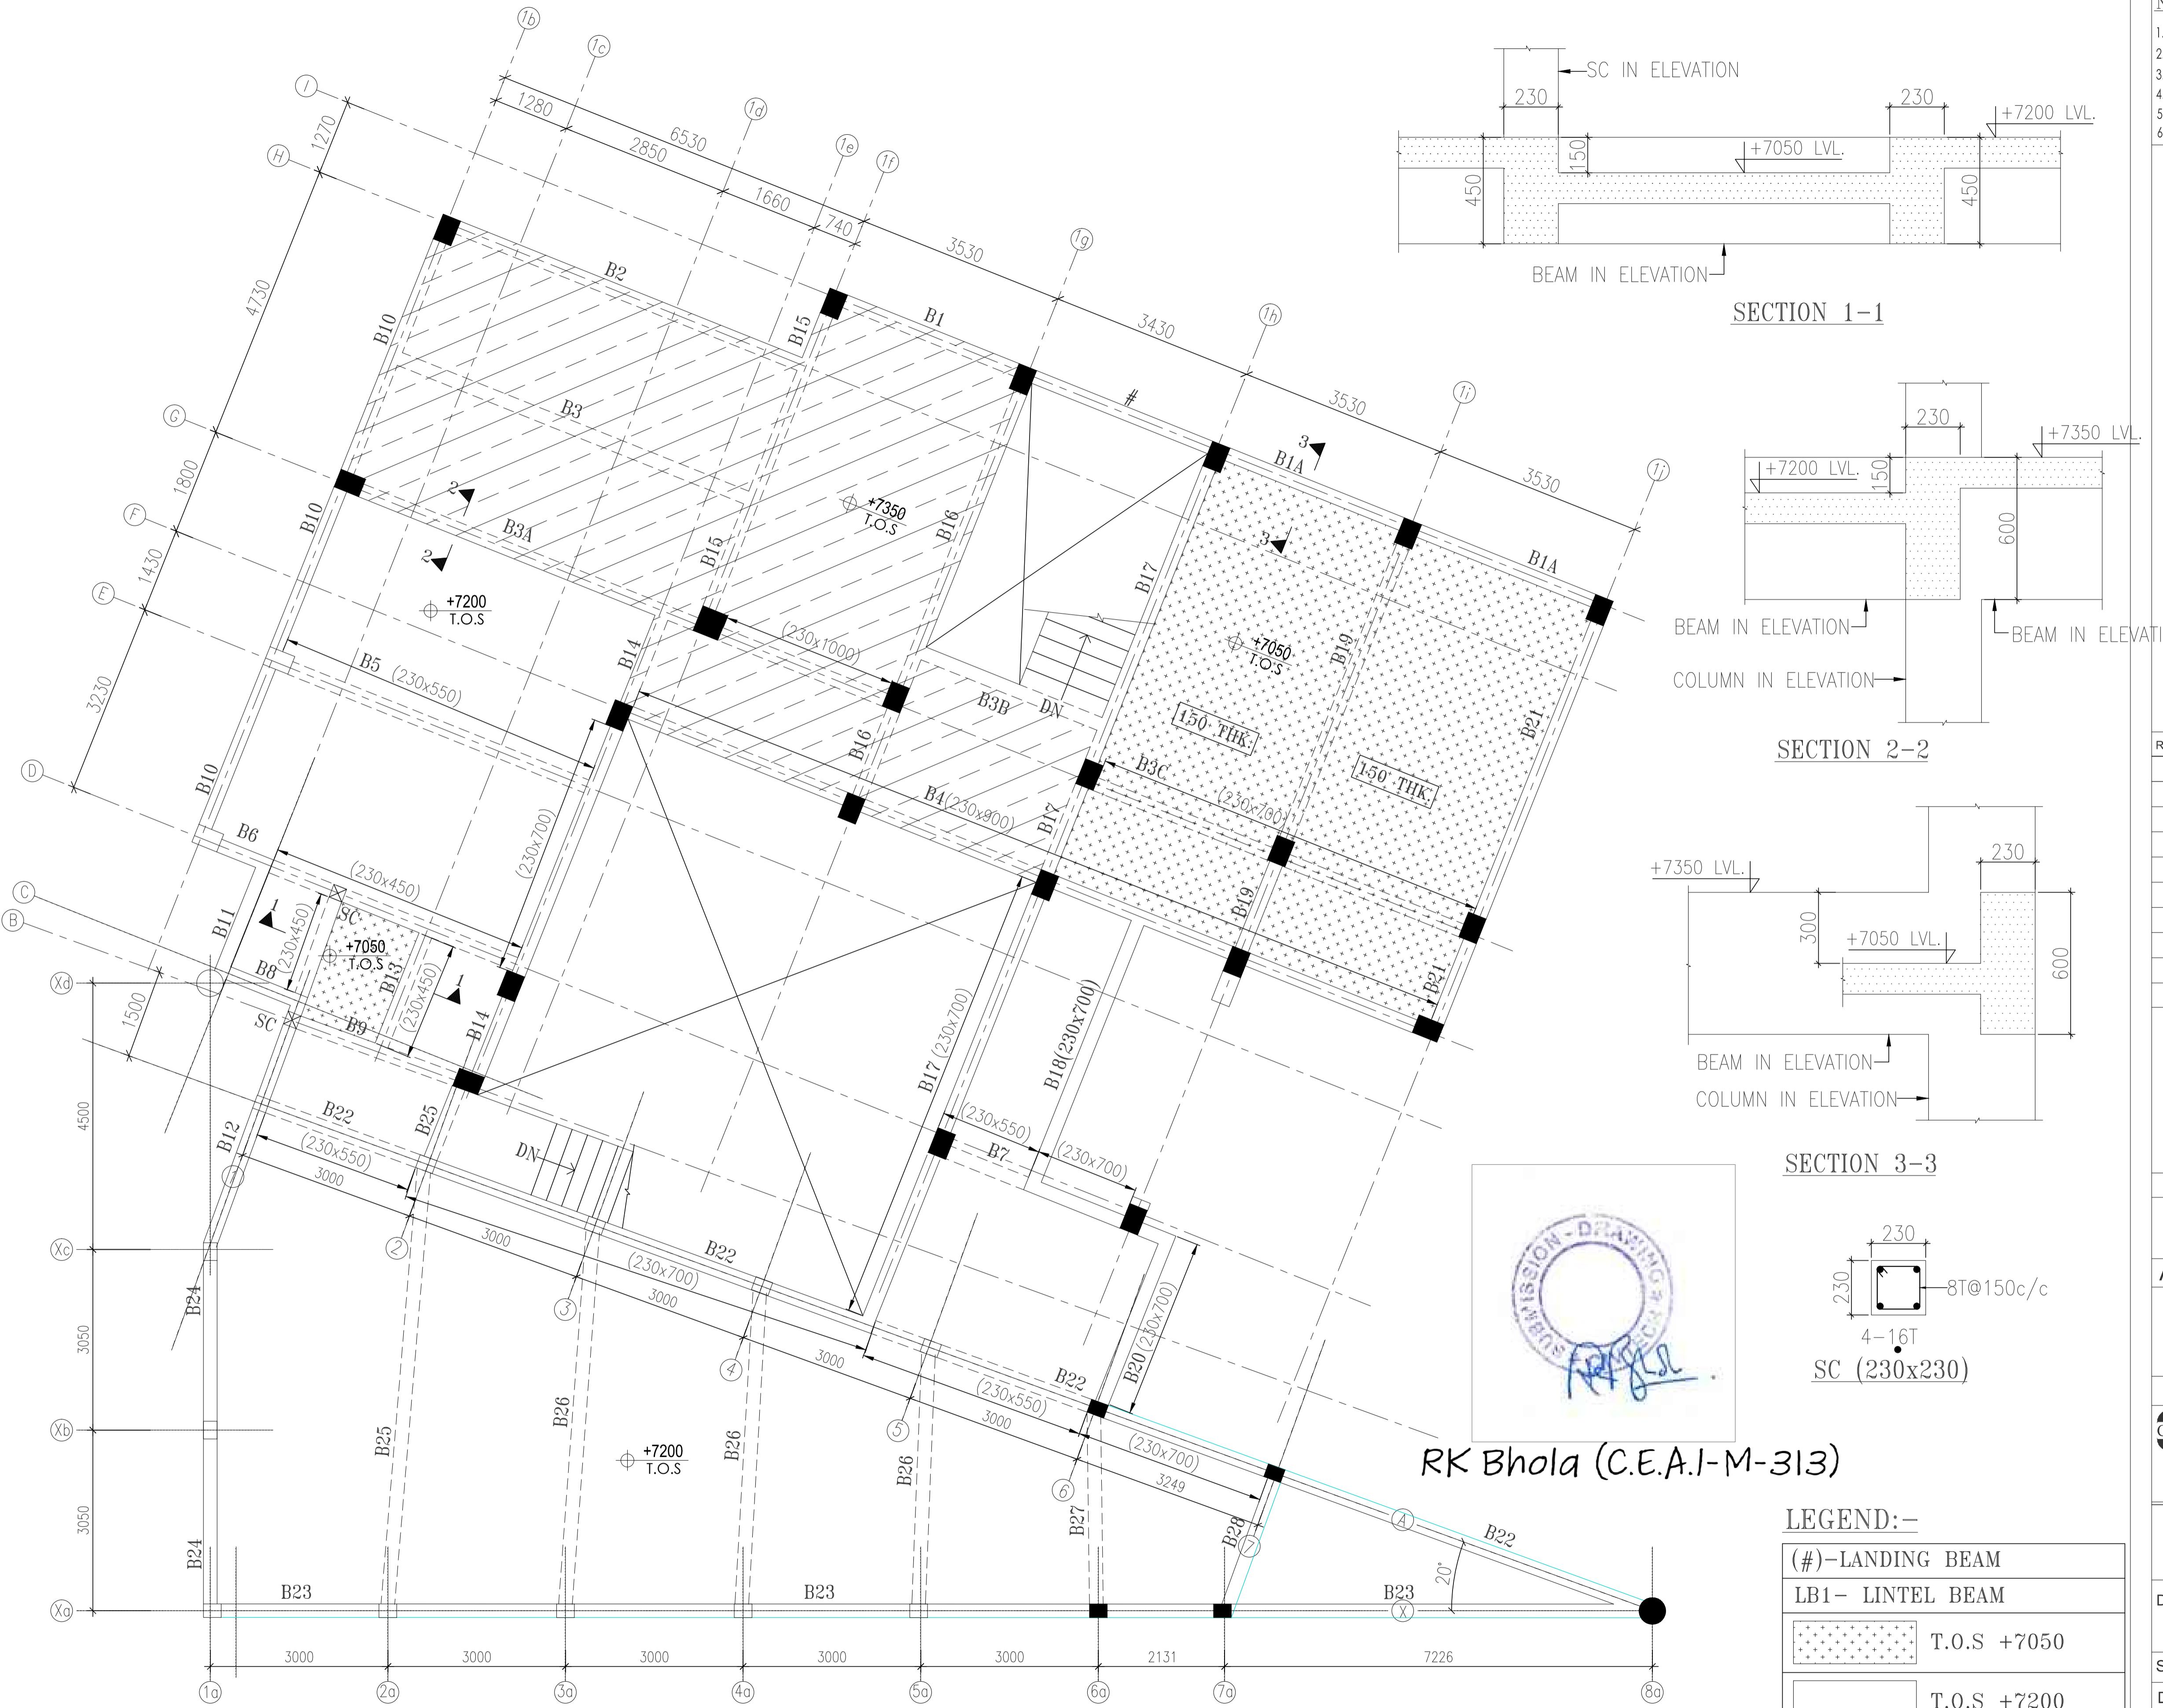
STRUCTURE ENGINEERS
CIVTECH CIVTECH CONSULTANTS PVT LTD
B-62, LAJPUT NAGAR-IV, NEW DELHI-110024
A-45 , SECTOR-4 , NOIDA-201301
PH. NO : 0120-2544084, E-mail - Projects@civtech.in

BUILDING TYPE ASHIANA UMANG COMMERCIAL
DRG. TITLE: SECOND FLOOR BEAM DETAIL

SCALE: NTS **KEY IN:**
DATE: 13-05-2024 **PLOTTED ON:**
DRAWN BY RAJAT **CHECKED** DEEPAK **APPROVED BY:** RKB.
DRG. NO. :- 682/S/COM/402 **REV.** R0
ISSUED FOR- SUBMISSION




RK Bhola (C.E.A.I-M-313)



RK Bhola (C.E.A.I-M-313)

LEGEND:-

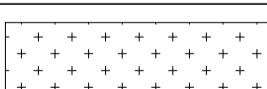(#)-LANDING BEAM	
LB1- LINTEL BEAM	
	T.O.S +7050
	T.O.S +7200
	T.O.S +7350

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STRUCTURE ENGINEERS

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PH. NO: 0120-2544084 E-mail: - Projects@civtech.in

BUILDING ASIANA HUMAN COMMERCIAL


DRG. TITLE:	SECOND FLOOR FRAMING PLAN
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SCALE: NTS KEY IN:


DATE.: 13-05-2024 PLOTTED ON:

DRAWN BY	CHECKED	APPROVED BY:
RAJAT	DEEPAK	RKB

DRG. NO. :- 682/S/COM/401 BEV.

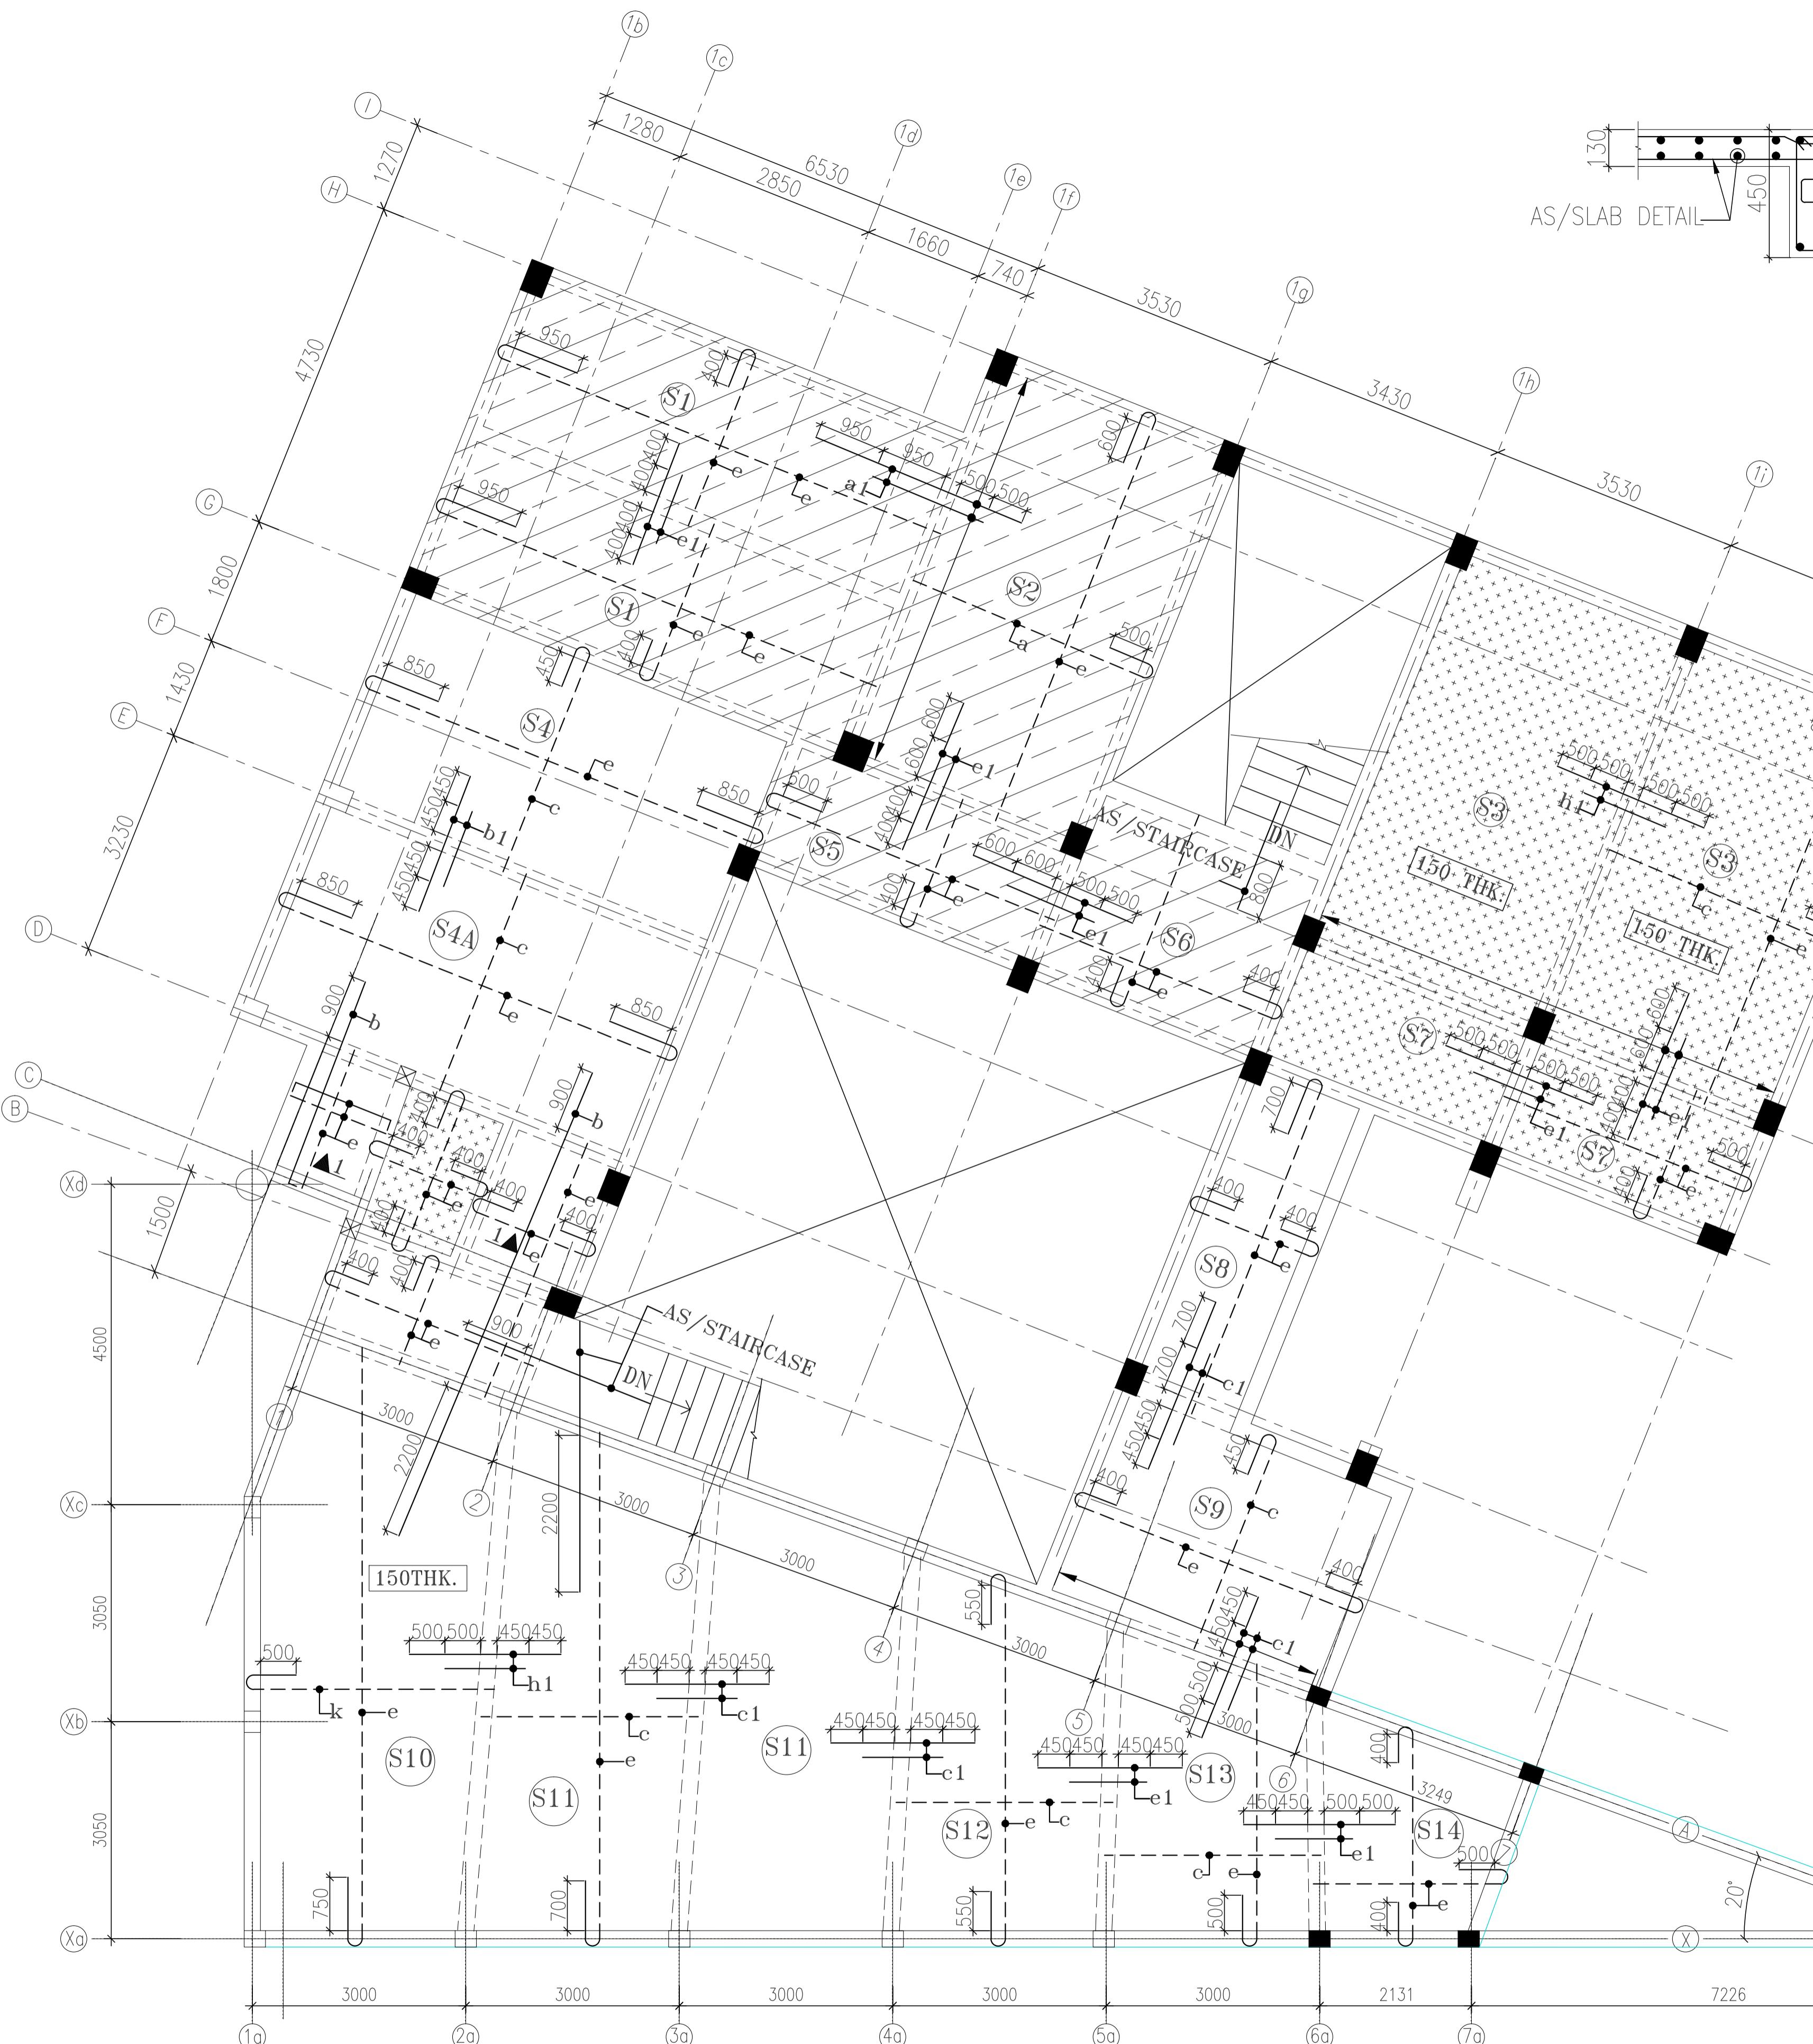

SECOND FLOOR SLAB DETAIL
ALL SLAB THICK 130mm U.O.S

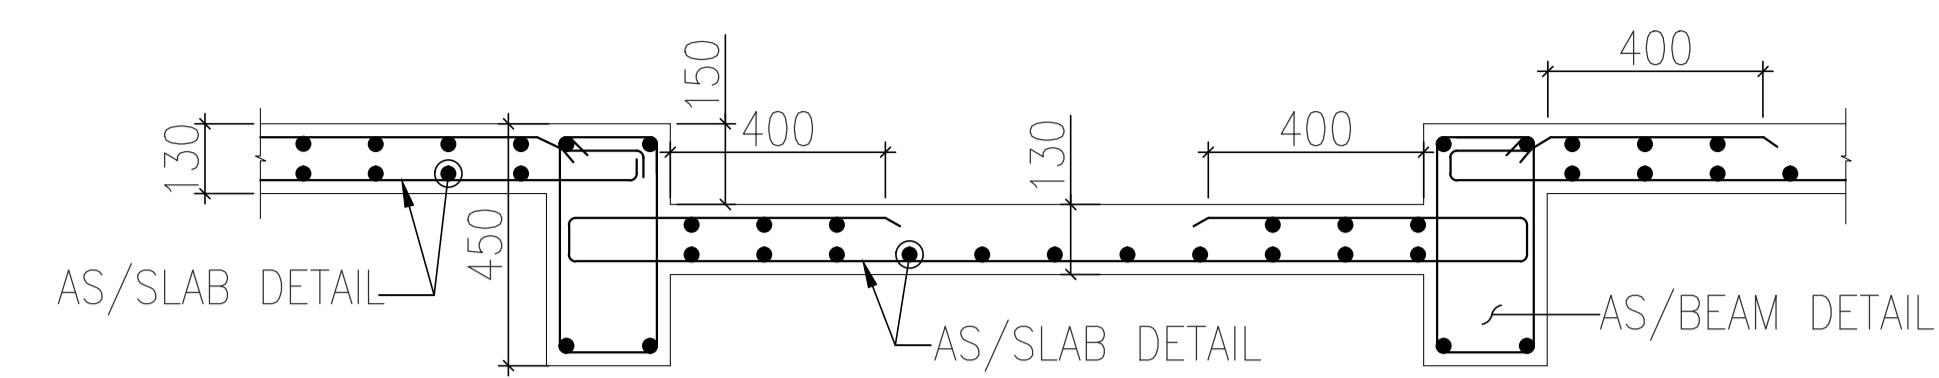

SECTION 1-1



RK Bhola (C.E.A.I-M-313)

LEGEND :-

TOP REINF.	
BOTTOM REINF.	

SLAB REINF. SCHEDULE

REINF. MKD.	REINF. & SPACING (mm)	REINF. MKD.	REINF. & SPACING (mm)
a	8T@100c/c	a1	8T@200c/c (NET SPACING 8T@100c/c)
b	8T@125c/c	b1	8T@250c/c (NET SPACING 8T@125c/c)
c	8T@150c/c	c1	8T@300c/c (NET SPACING 8T@150c/c)
d	8T@175c/c	d1	8T@350c/c (NET SPACING 8T@175c/c)
e	8T@200c/c	e1	8T@400c/c (NET SPACING 8T@200c/c)
f	10T@100c/c	f1	10T@200c/c (NET SPACING 10T@100c/c)
g	10T@125c/c	g1	10T@250c/c (NET SPACING 10T@125c/c)
h	10T@150c/c	h1	10T@300c/c (NET SPACING 10T@150c/c)
k	10T@175c/c	k1	10T@350c/c (NET SPACING 10T@175c/c)

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 PH. NO: 0120-2544084, E-mail - Projects@civtech.in

BUILDING TYPE ASHIANA UMANG COMMERCIAL

DRG. TITLE: SECOND FLOOR SLAB DETAIL

SCALE: NTS KEY IN:
 DATE.: 13-05-2024 PLOTTED ON:

DRAWN BY CHECKED APPROVED BY:
 RAJAT DEEPAK RKB.

DRG. NO. :- 682/S/COM/403 REV.
 ISSUED FOR:- SUBMISSION