


PROJECT NAME :
BALAJI AASHIYANA II

DEVELOPER NAME :
BALAJI BUILDER

ARCHITECTS :
4 INSIDE
ARCHITECTURE N INTERIORS
Plot no. 72, S.P. Marg, C- Scheme
Jaipur, Rajasthan, India
cont: +91 9950595991, 91
9982812777
e.mail: 4insideofficial@gmail.com

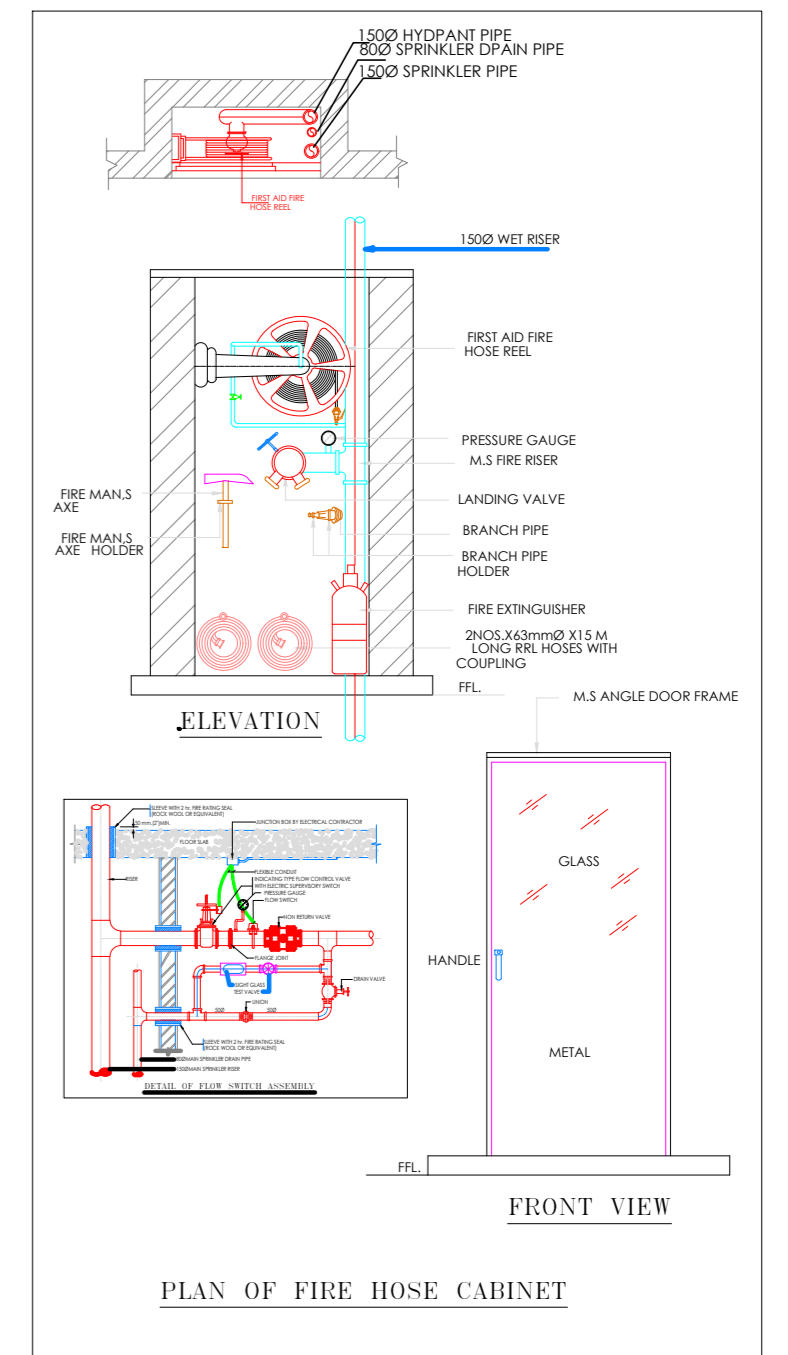

LEGEND:-

FIRE HYDRANT MS PIPE	
BALL VALVE	
EXTERNAL FIRE HYDRANT	
EXTERNAL FIRE HOSE CABINAT	
FIRE HOSE CABINAT	
UPRIGHT SPRINKLER HEAD	
PENDENT SPRINKLER HEAD	
SIDE WALL SPRINKLER HEAD	
FIRE EXINGUISHER	
FLOW SWITCH	
ISOLATION VALVE	
2 WAY FIRE BRIGADE INLET	


S.NO.	DATE	REVISION DESCRIPTION
GENERAL NOTES:		
1.		All dimension on this drawing are in MMS System Only written dimensions are to be followed drawing should not be scaled.
2.		All measurements must be checked and verified by the contractors prior to execution of work at the site.
3.		This drawing is to be read in conjunction with all relevant structural, services & civil drawings.
4.		Architectural drawings are to be followed for the location of all structural members & masonry walls, for sizes & reinforcement details of structural members, relevant structural drawings are to be referred.
5.		Any discrepancies between architectural, structural and services drawings must be brought to the notice of the architects immediately & prior to execution at site.
6.		Co-ordination with services such as hvac, plumbing & electrical, etc. is the responsibility of the contractor.
7.		All masonry walls should be aligned with the columns as indicated on the plan, irrespective of the position as calculated with the dimensions.
8.		For details, refer relevant large scale detail drgs. as indicated.

PROJECT:
PLOT NO. 49,50,62 & 63
SCHEME NO.17 LAXMAN REKHA
JAIPUR.

NAME OF DRAWING:
STILT FLOOR FIRE FIGHTING PLAN
SITE EXTERNAL FIRE HYDRANT & FIRE PIPE ROUTE PLAN

DRAWING	NORTH:
WORKING DRAWING	
PROJECT NO.:	DATE:
	21, Nov. - 2024
SCALE:	REV NO.:
NTS	R-0

DRAWING NO.:	PROJECT	CATEGORY	BLOCK	FLOOR	TYPE	NUMBER	DRAWING PATH:
A-201							

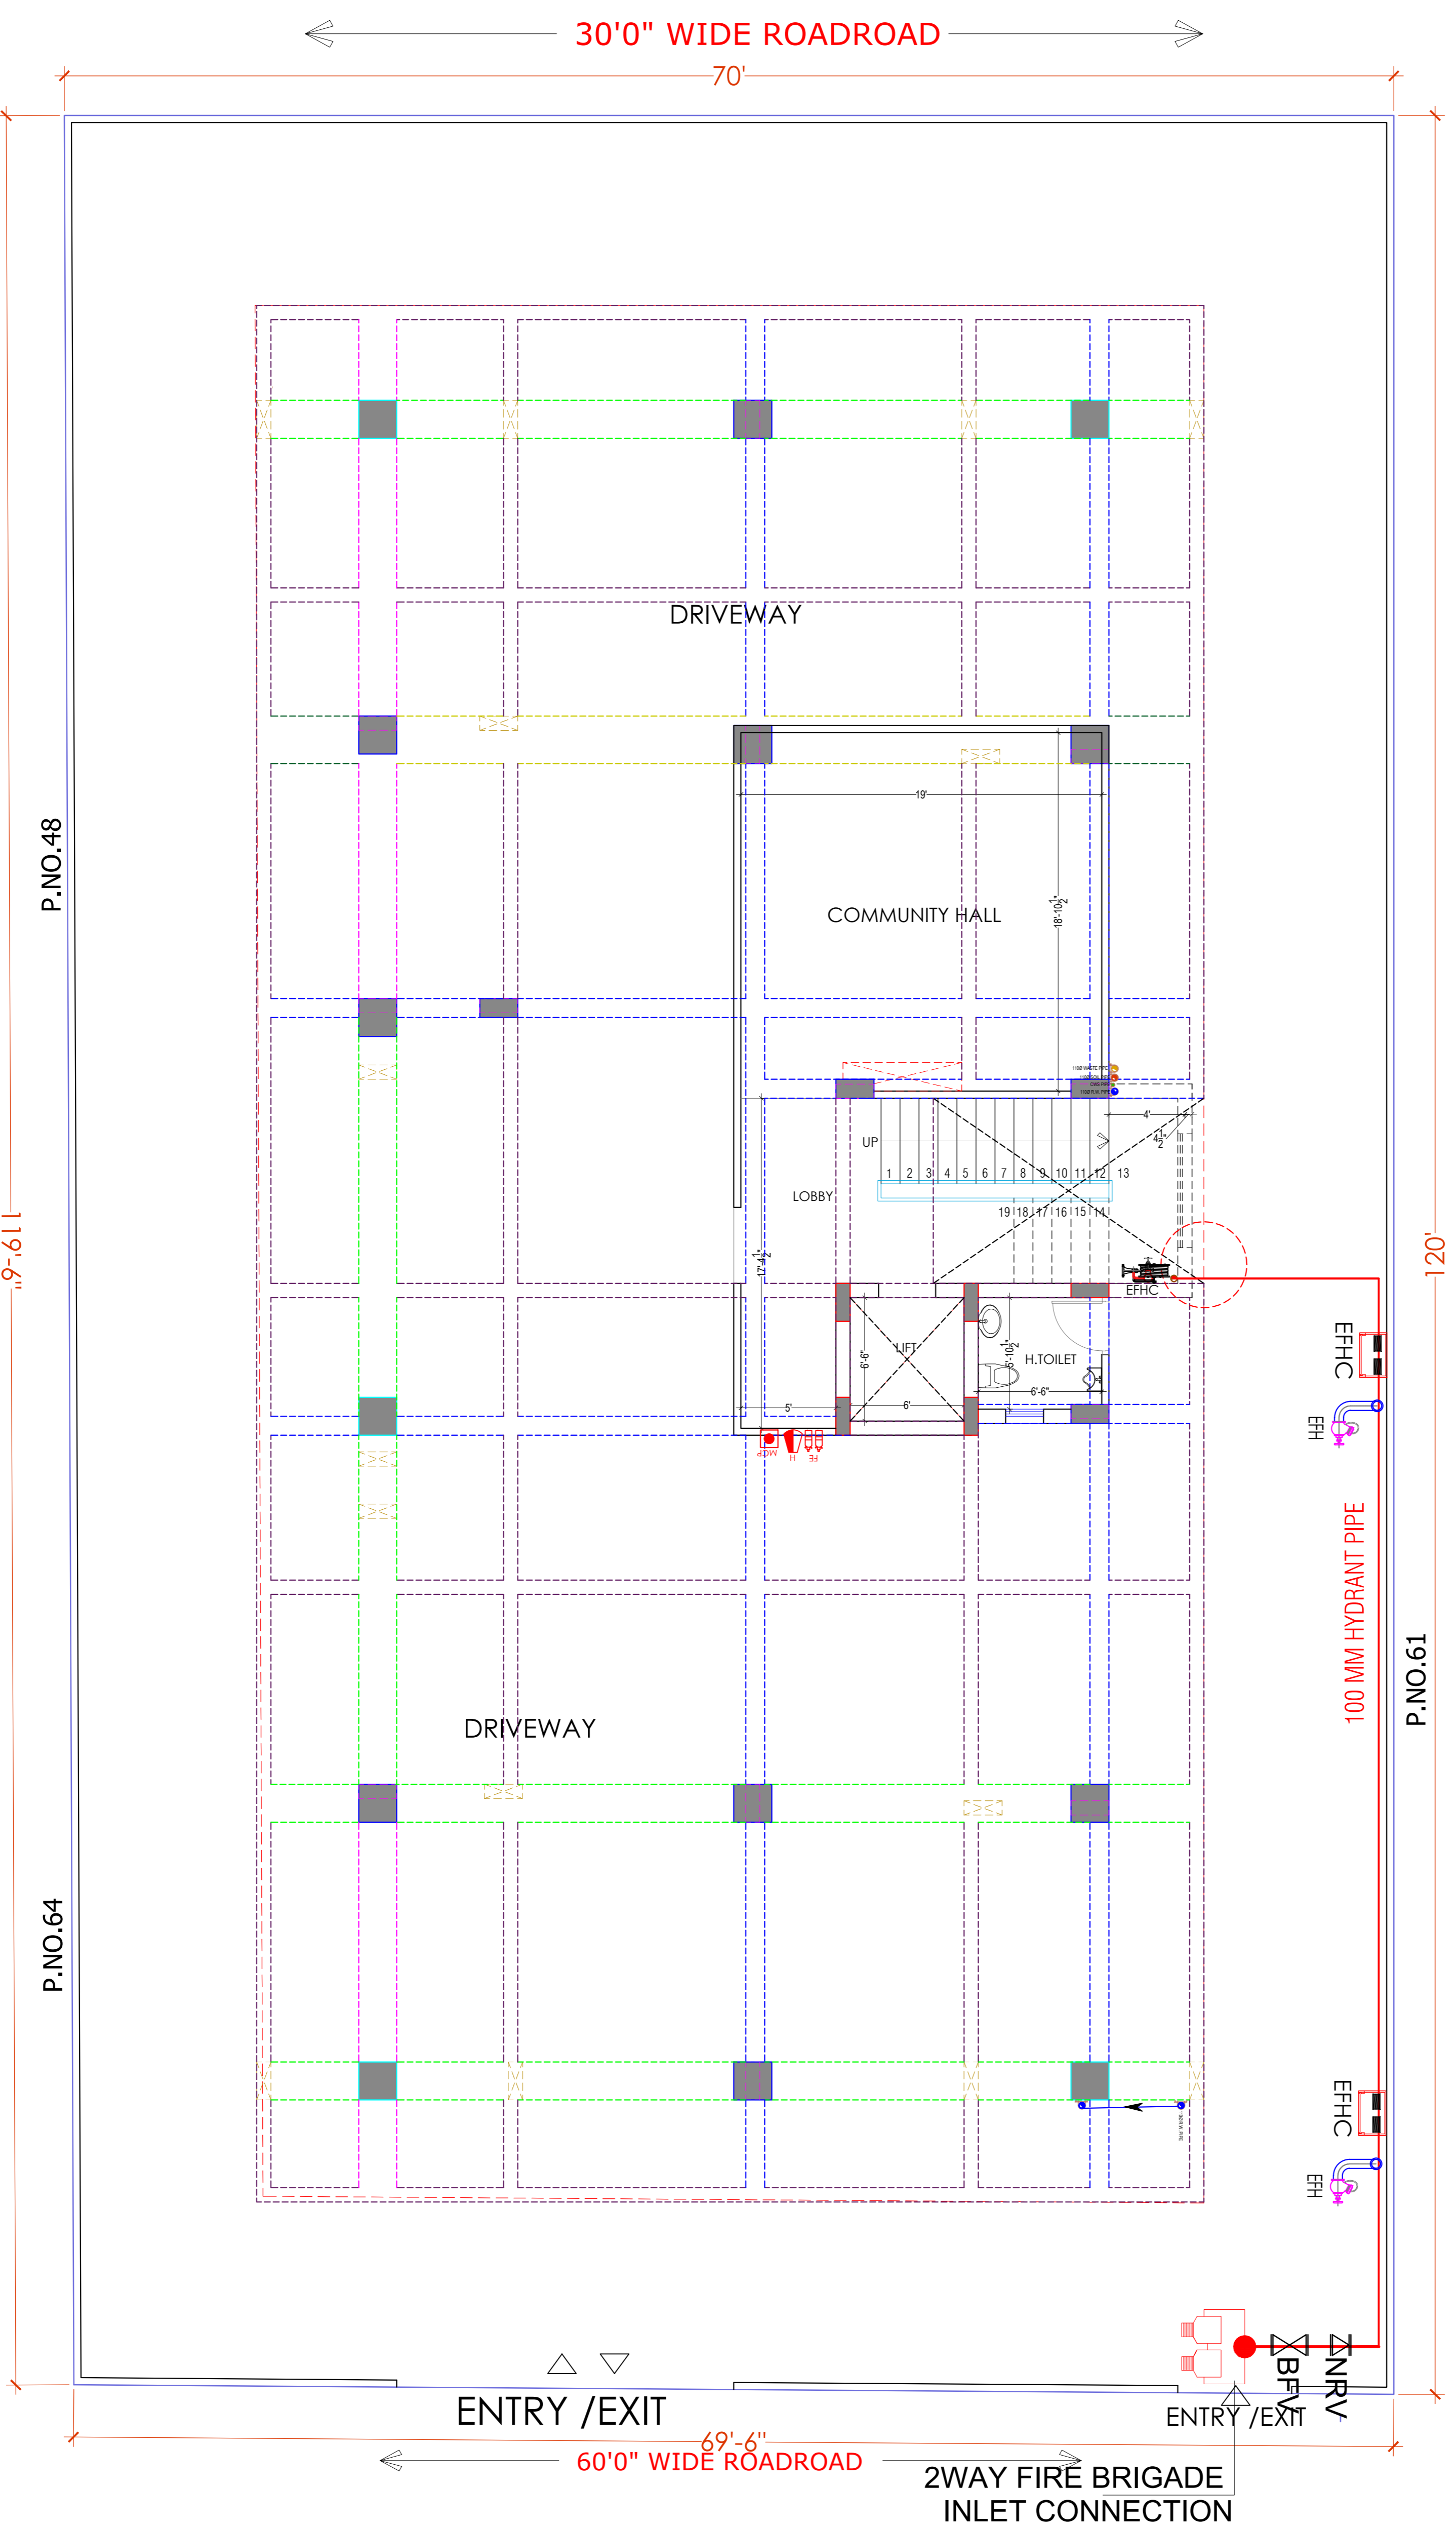

Er. SANJEEV SHARMA
B.E (Electrical)



For BALAJI BUILDERS
Proprietor

STILT FLOOR FIRE FIGHTING PLAN
SITE EXTERNAL FIRE HYDRANT & FIRE PIPE ROUTE PLAN

PROJECT NAME :
BALAJI AASHIYANA II

DEVELOPER NAME :
BALAJI BUILDER

ARCHITECTS :
4 INSIDE
ARCHITECTURE N INTERIORS
Plot no. 72, S.P. Marg, C-Scheme
jaipur, rajasthan, India
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9982812777
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Sharma
Er. SANJEEV SHARMA
B.E (Electrical)

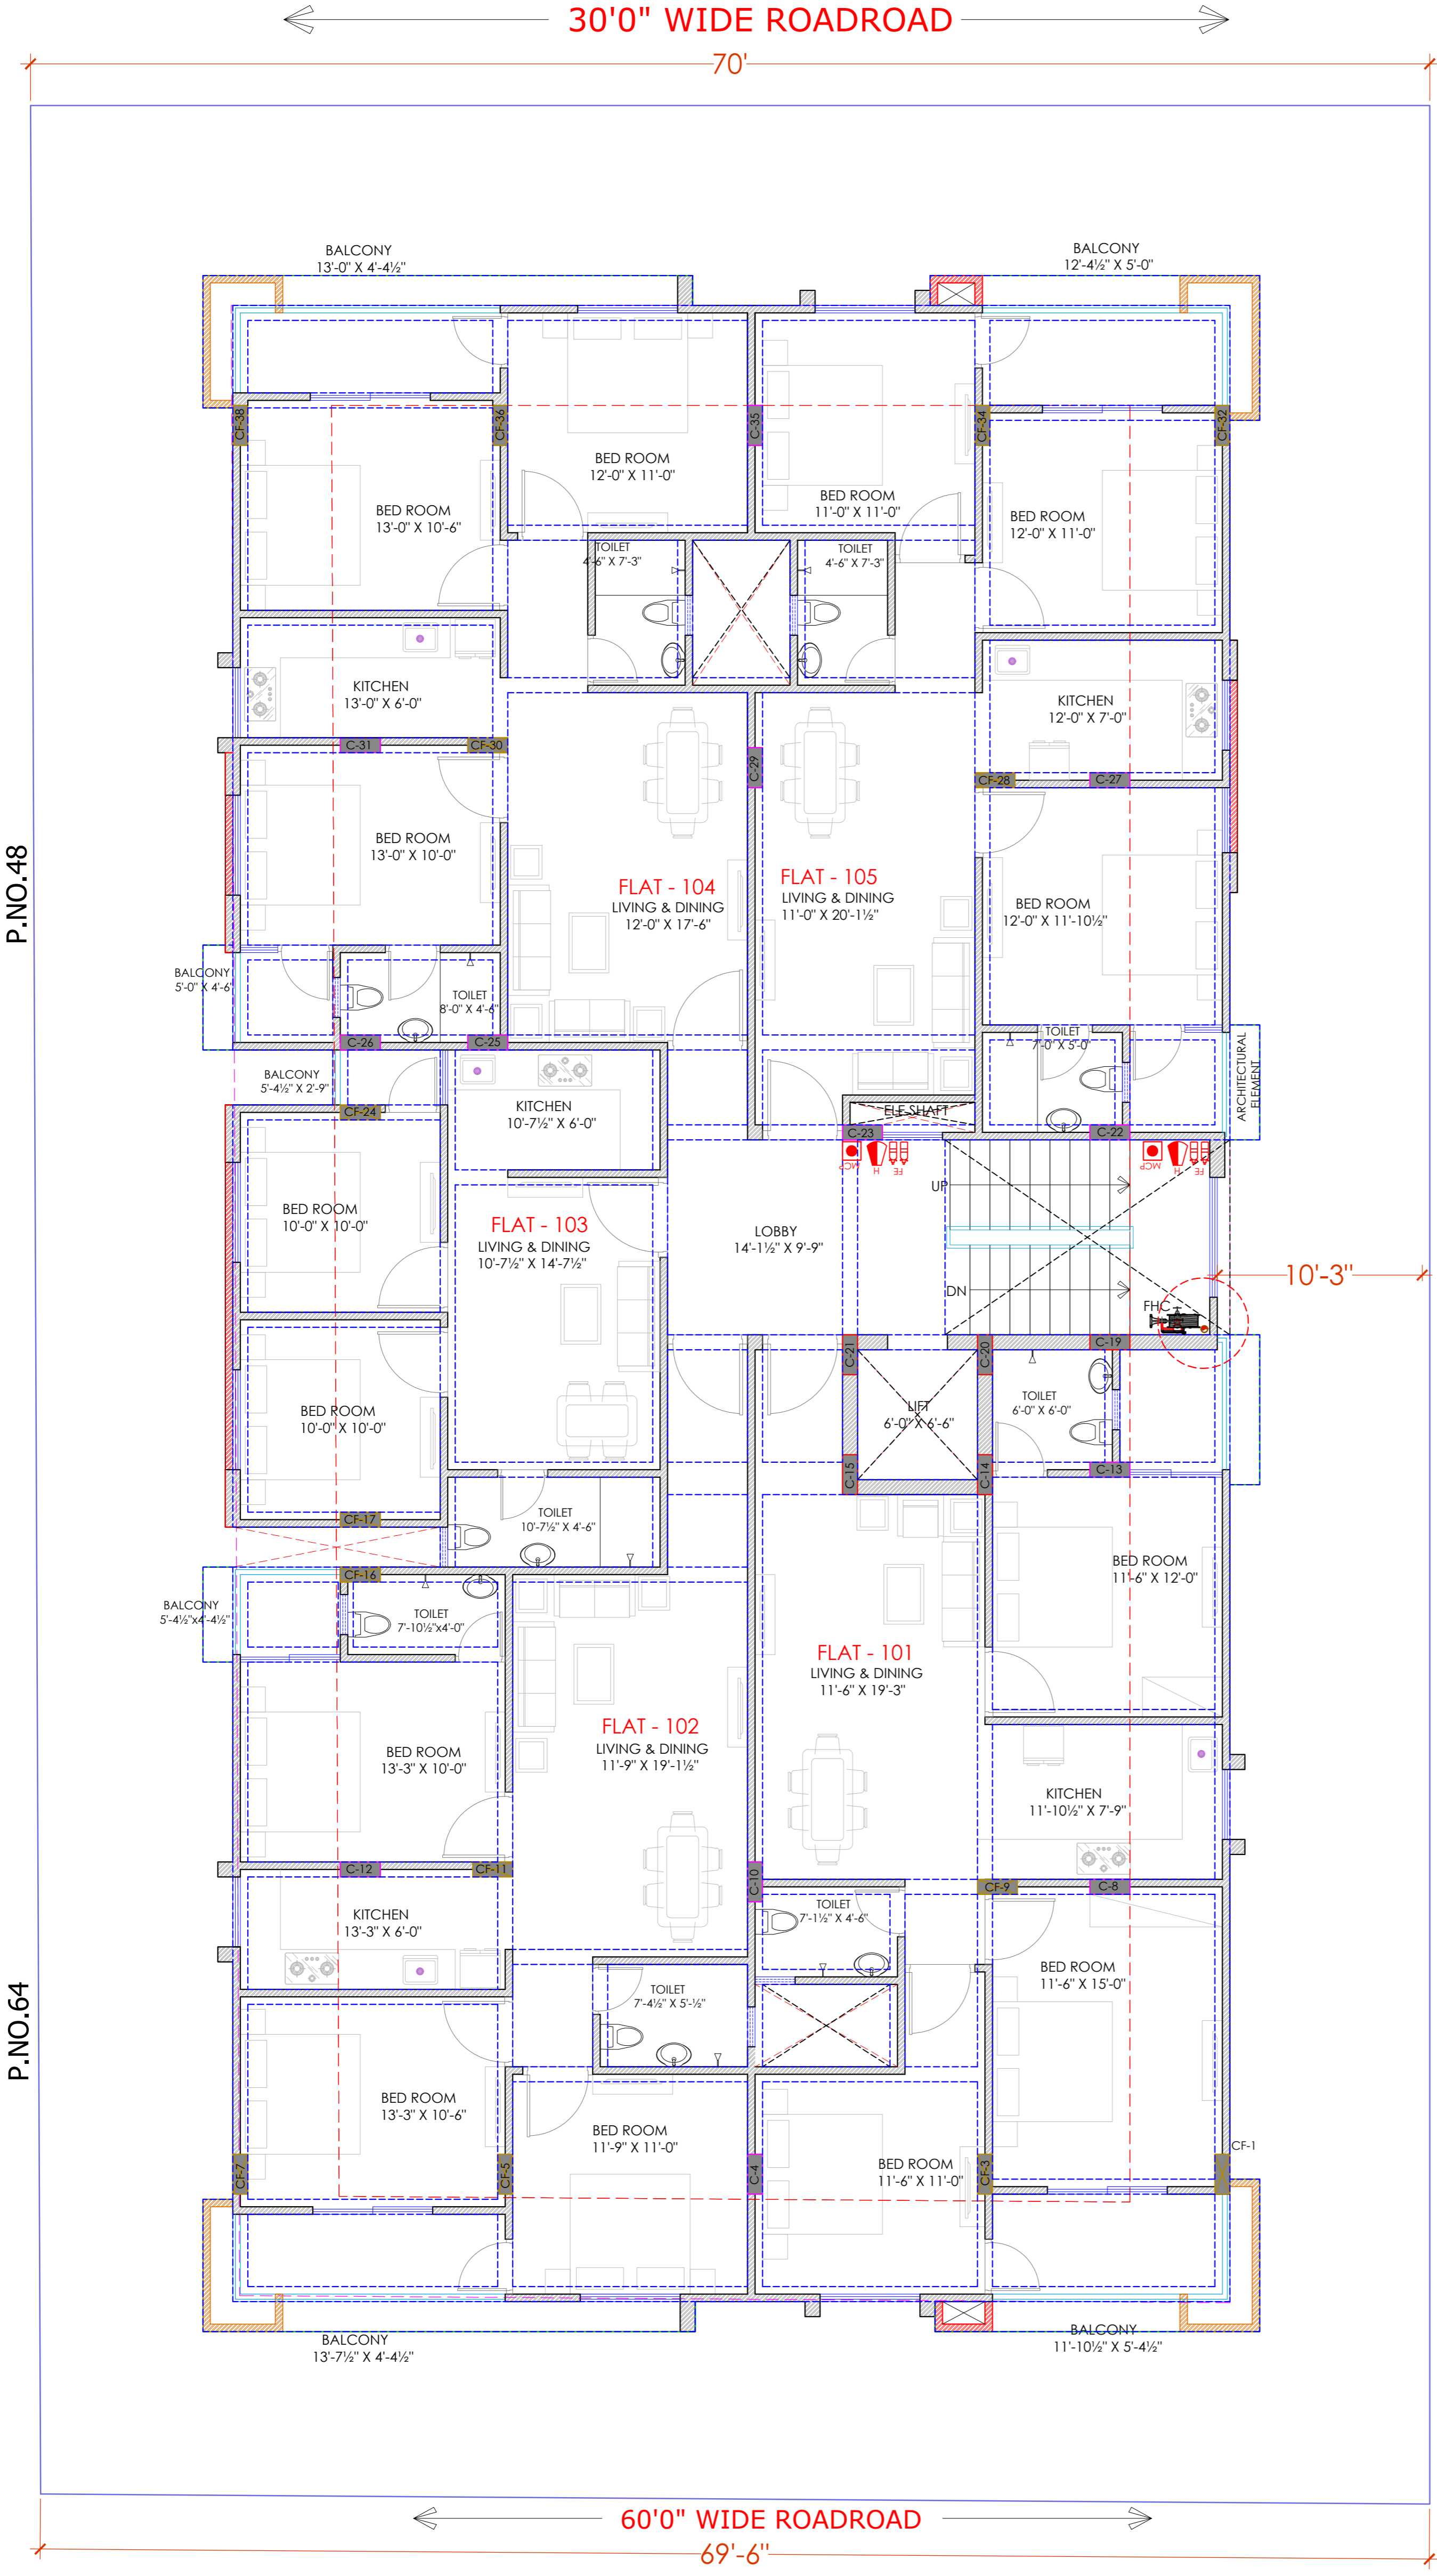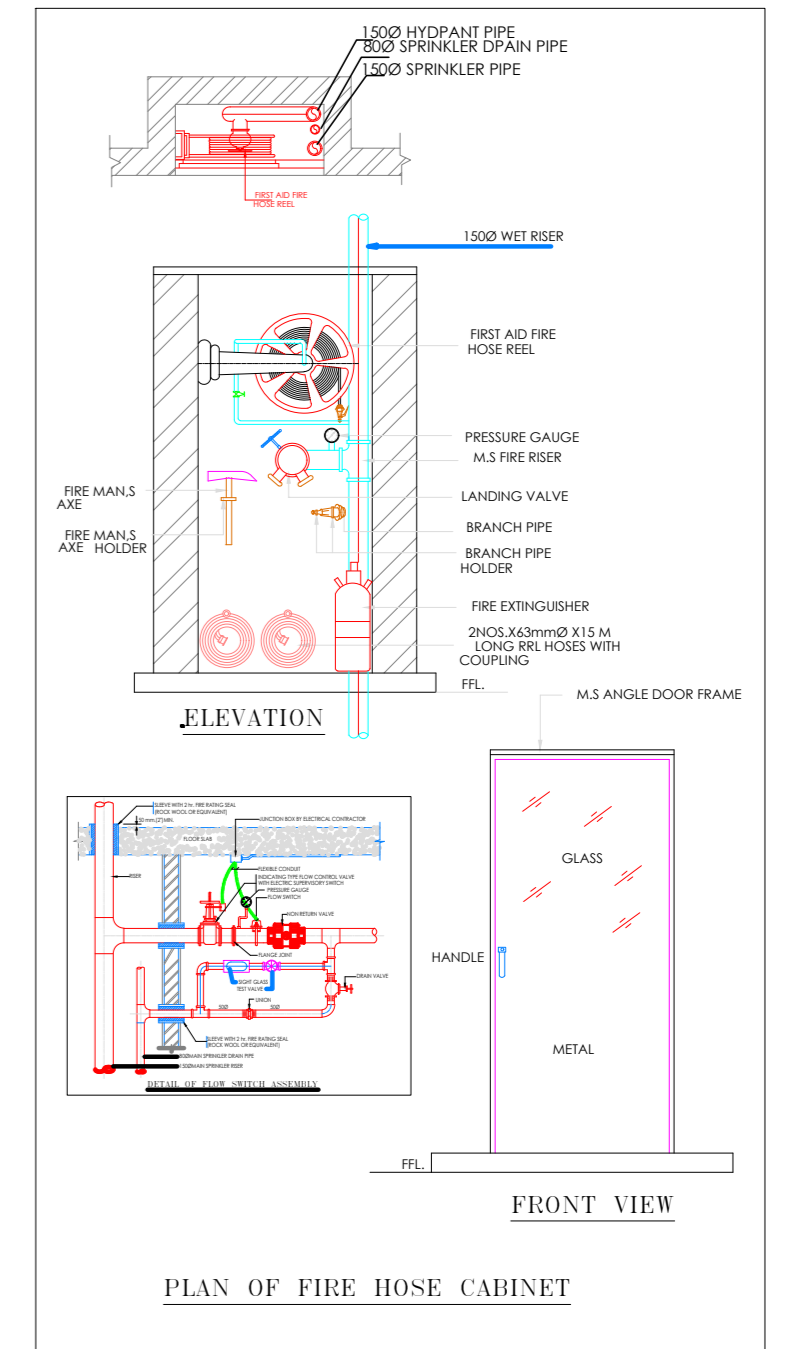For BALAJI BUILDERS
Proprietor

**TYPICAL FLOOR FIRE FIGHTING PLAN(GROUND TO FIFTH)
FHC, MCP, HOOTER & FIRE EXTINGUISHER PLAN**

PROJECT:
**PLOT NO. 49,50,62 & 63
SCHEME NO.17 LAXMAN REKHA
JAIPUR.**

NAME OF DRAWING:
**TYPICAL FLOOR FIRE FIGHTING PLAN
(GROUND TO FIFTH) FHC, MCP,
HOOTER & FIRE EXTINGUISHER PLAN**


DRAWING WORKING DRAWING	NORTH:
PROJECT NO. :	DATE : 21, Nov. - 2024
SCALE: NTS	REV NO. : R-0

DRAWING NO. :	PROJECT	CATEGORY	BLOCK	FLOOR	TYPE	NUMBER	DRAWING PATH:
A-201							

PROJECT NAME :
BALAJI AASHIYANA II

DEVELOPER NAME :
BALAJI BUILDER

ARCHITECTS :
4 INSIDE
ARCHITECTURE N INTERIORS
Plot no. 72, S.P. Marg, C- Scheme
jaipur, rajasthan, India
cont: +91 9950595991, 91
9982812777
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LEGEND: -

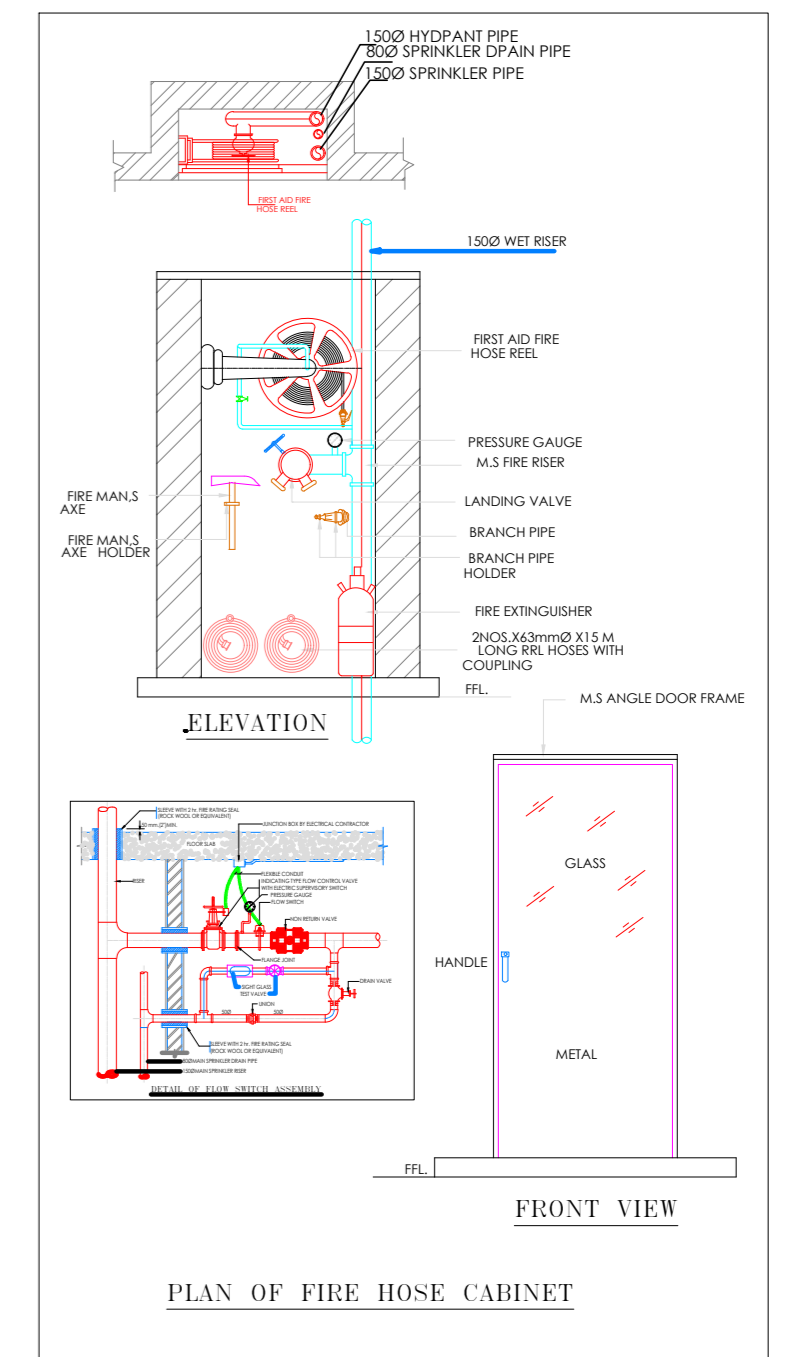FIRE HYDRANT MS PIPE	
BALL VALVE	
EXTERNAL FIRE HYDRANT	
EXTERNAL FIRE HOSE CABINAT	
FIRE HOSE CABINAT	
UPRIGHT SPRINKLER HEAD	
PENDENT SPRINKLER HEAD	
SIDE WALL SPRINKLER HEAD	
FIRE EXINGUISHER	
FLOW SWITCH	
ISOLATION VALVE	
2 WAY FIRE BRIGADE INLET	


- GENERAL NOTES:
- All dimension on this drawing are in MKS System Only written dimensions are to be followed drawing should not be scaled.
 - All measurements must be checked and verified by the contractors prior to execution of work at the site.
 - This drawing is to be read in conjunction with all relevant structural, services & scaffolding drawings.
 - Architectural drawings are to be followed for the location of all structural members & masonry walls, for sizes & reinforcement details of structural members, relevant structural drawings are to be referred.
 - Any discrepancies between architectural, structural and services drawings must be brought to the notice of the architects immediately & prior to execution at site.
 - Co-ordinate with services such as hvac, plumbing & electrical, etc. is the responsibility of the contractor.
 - All masonry walls should be aligned with the columns as indicated on the plan, irrespective of the position as calculated with the dimensions.
 - For details, refer relevant large scale detail drgs. as indicated.

PROJECT:
**PLOT NO. 49,50,62 & 63
SCHEME NO.17 LAXMAN REKHA
JAIPUR.**

NAME OF DRAWING:
**TARRACE FLOOR FIRE FIGHTING PLAN,
FIRE SCHEMATIC LAYOUT**

DRAWING WORKING DRAWING	NORTH:
PROJECT NO.:	DATE: 21, Nov. - 2024
SCALE: NTS	REV NO. : R-0

DRAWING NO.:	PROJECT	CATEGORY	BLOCK	FLOOR	TYPE	NUMBER	DRAWING PATH:
A-201							

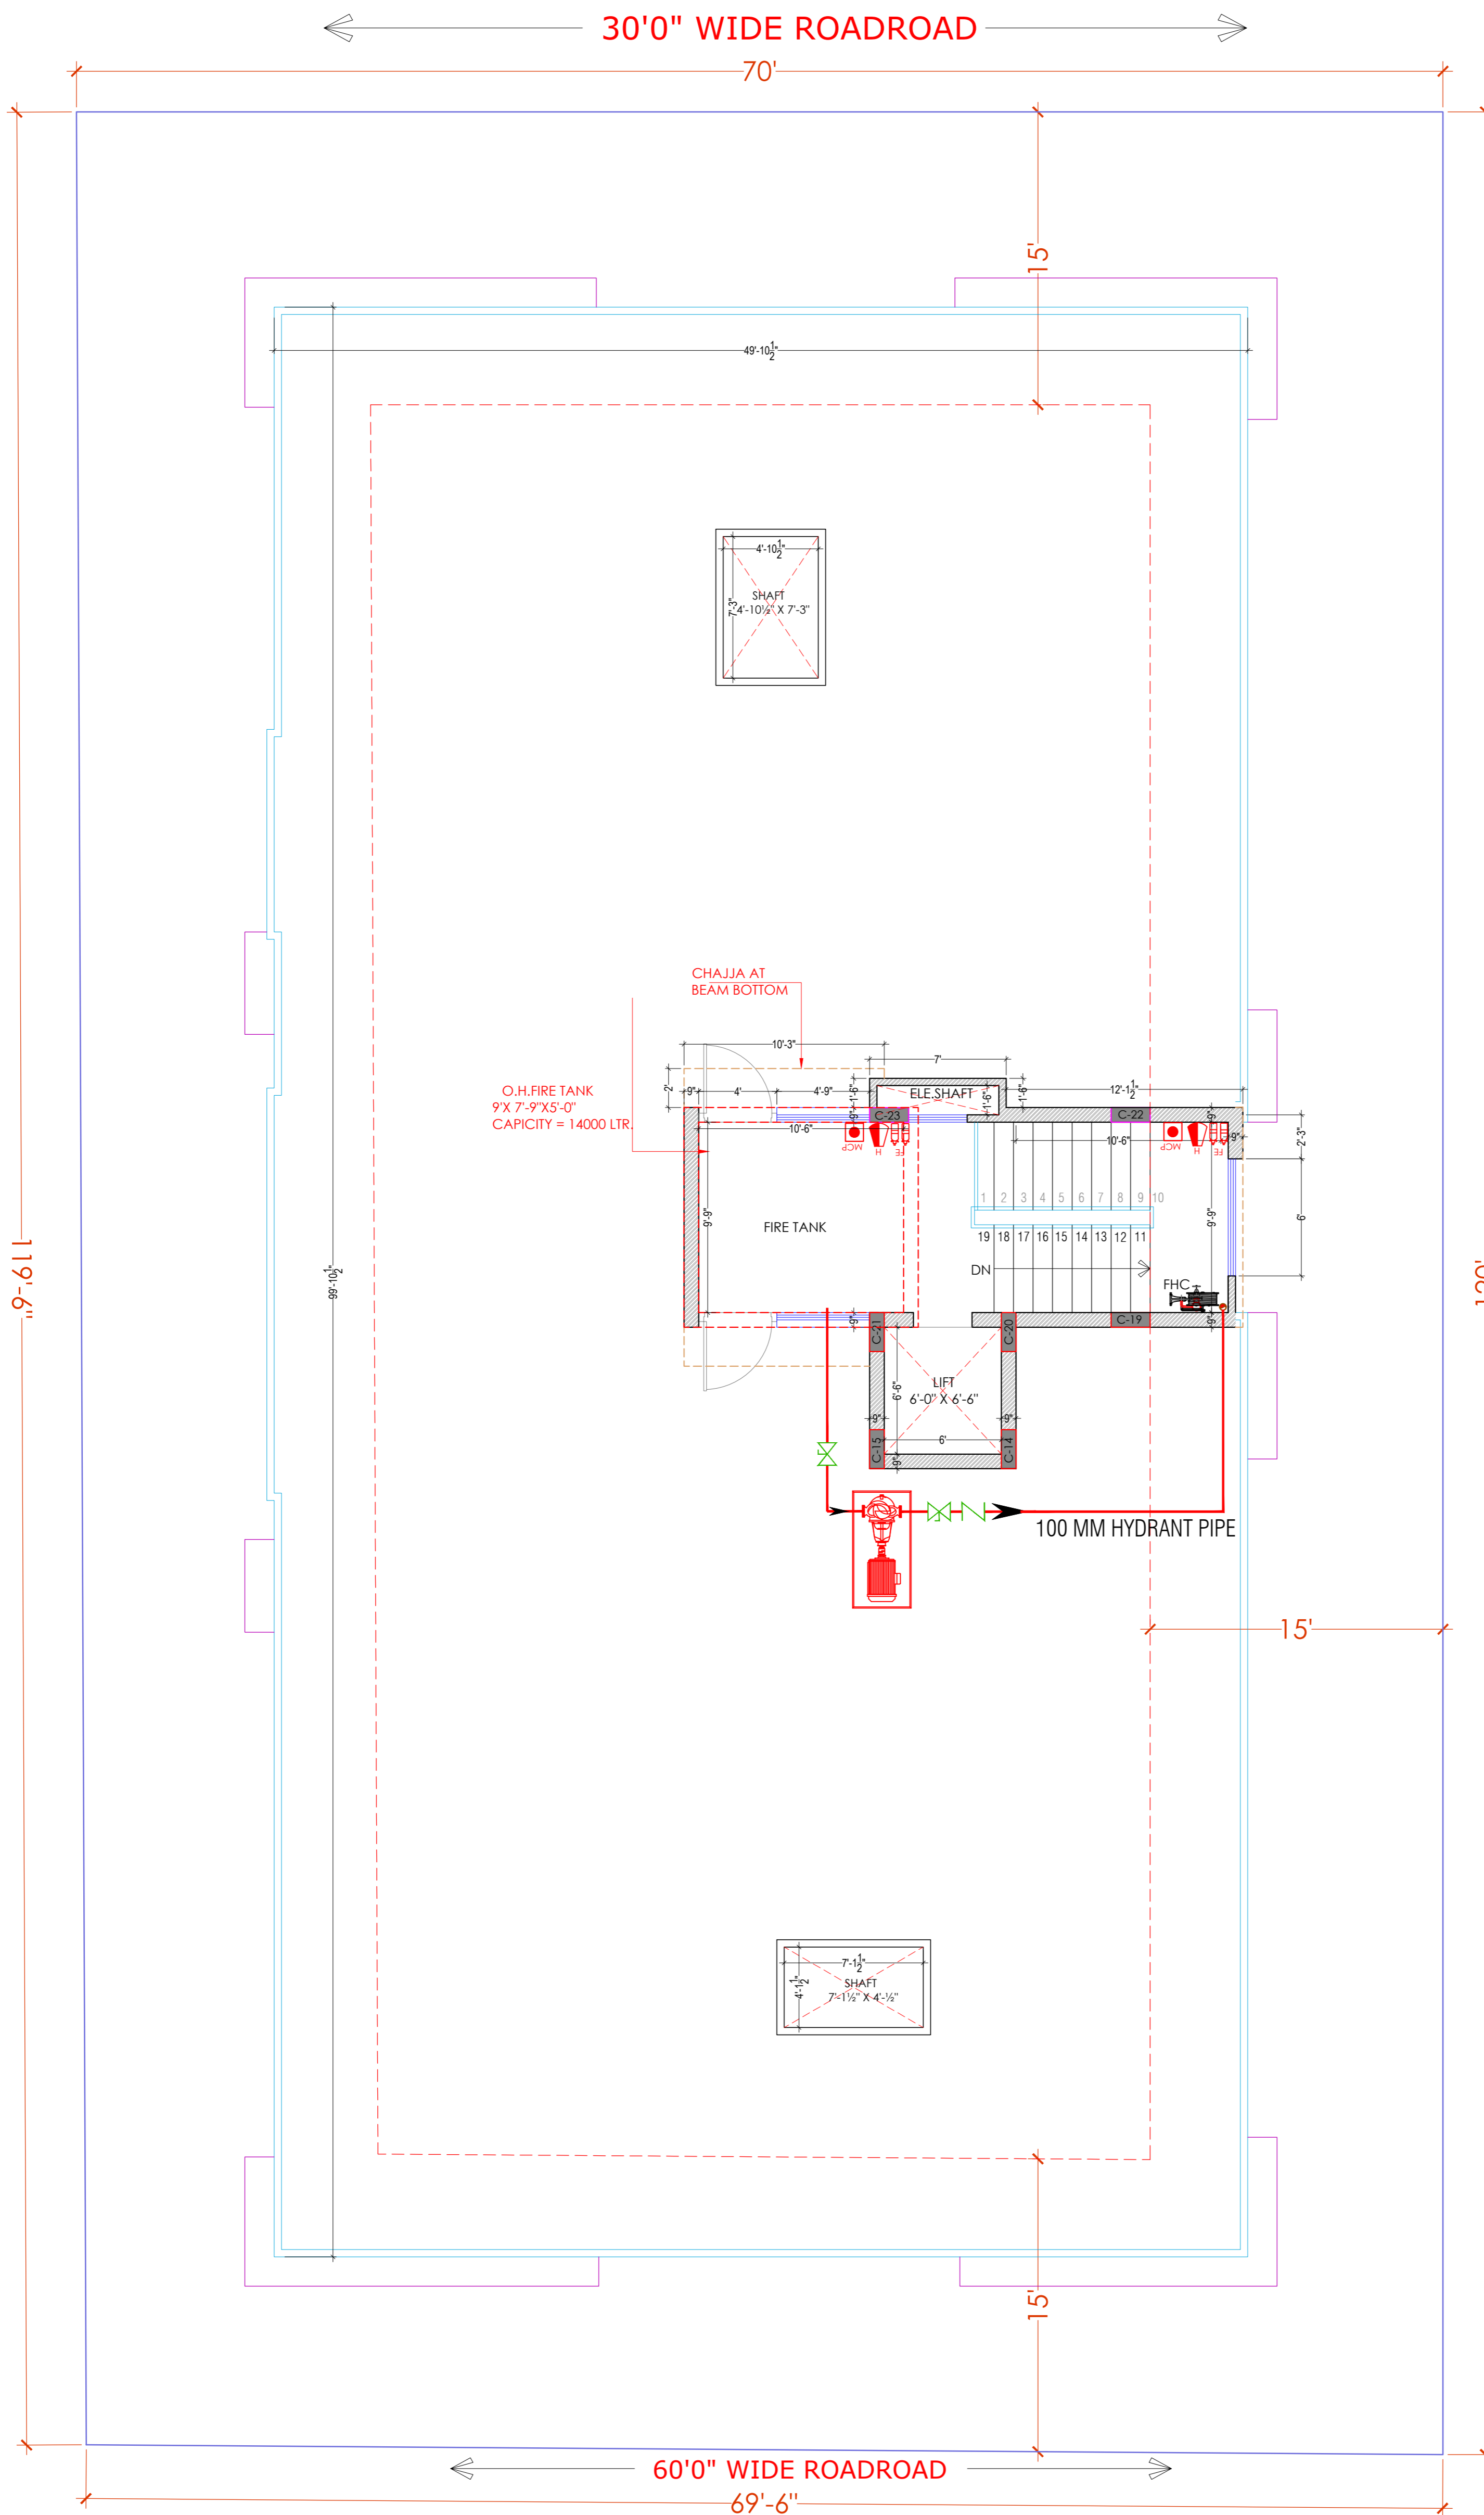

Er. Sanjeev Sharma
Er. SANJEEV SHARMA
B.E (Electrical)

For **BALAJI BUILDERS**
Proprietor

**TARRACE FLOOR FIRE FIGHTING PLAN,
FIRE SCHEMATIC LAYOUT**